
# SHUMAKER RESIDENCE

183 DAVIS BRIDGE ROAD BERNVILLE, PA 19506

PENN TOWNSHIP - BERKS COUNTY

## NEW CONSTRUCTION

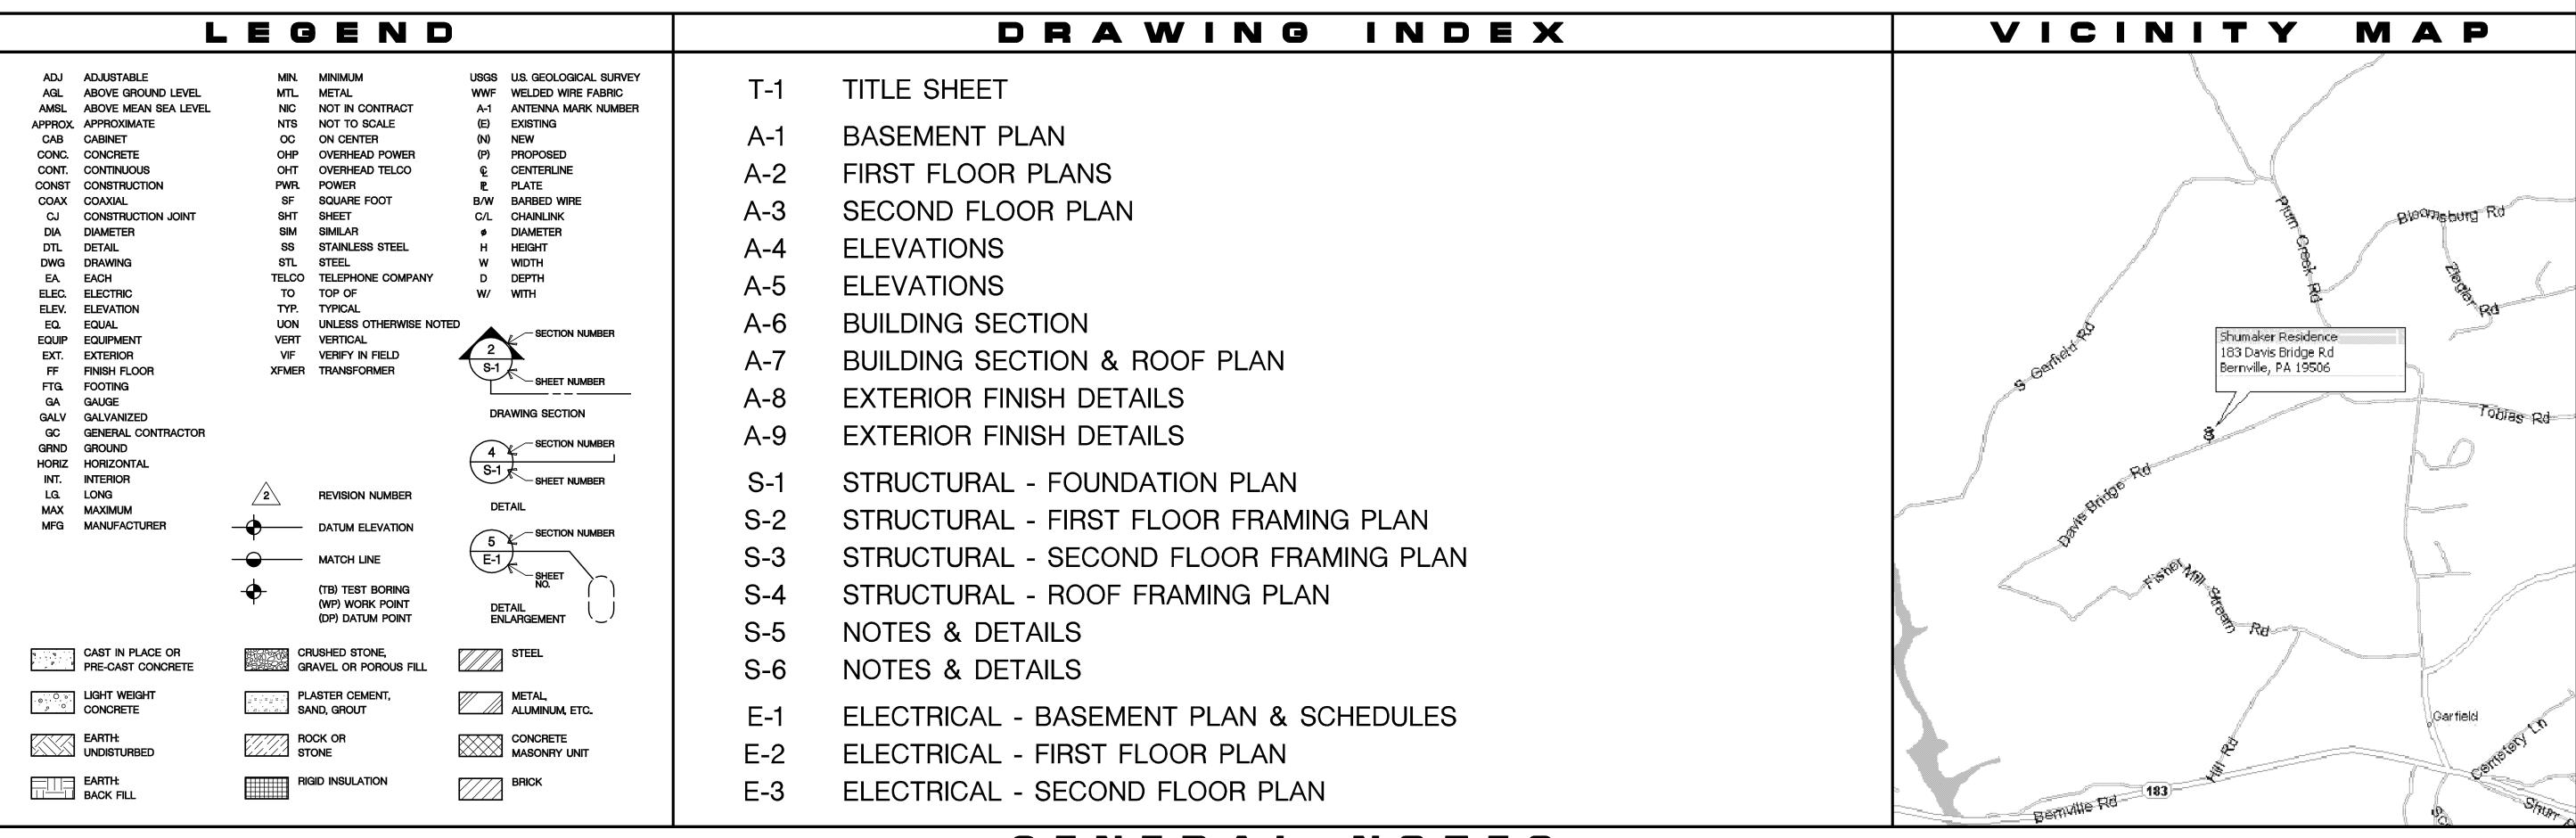

### GENERAL NOTES

- ALL WORK SHALL BE DONE IN ACCORDANCE WITH THE LATEST EDITION OF THE IRC CODE ADOPTED BY PENN TOWNSHIP, BERKS COUNTY IN THE COMMONWEALTH OF PENNSYLVANIA. CONTRACTOR TO HAVE ALL REQUIRED LOCAL LICENSES.
- GENERAL CONTRACTOR SHALL VERIFY ALL EXISTING DIMENSIONS, STRUCTURE AND MATERIALS, AND SHALL BRING ANY DISCREPANCIES TO THE IMMEDIATE ATTENTION OF THE ARCHITECT.
- CONTRACTOR TO HAVE INSURANCE AS REQUIRED BY OWNER.
- THE USE OF THE PENNSYLVANIA ONE-CALL SYSTEM, INC. IS REQUIRED PRIOR TO ANY EXCAVATION. COORDINATE RELOCATION OF UTILITIES AS REQUIRED.
- FOLLOWING NOTES ARE MINIMUM STANDARDS FOR THE PROJECT. ALL NOTES ON DRAWINGS SUPERSEDES ALL COVER SHEET GENERAL NOTES.
- PROVIDE PORTABLE JOB TOILET AND TELEPHONE ON SITE FOR THE DURATION OF THE PROJECT. (AS REQUIRED BY OWNER).
- RELOCATION OF EXISTING TREES AND SHRUBS TO BE BY OWNER. FINAL SEEDING AND LANDSCAPING TO BE PROVIDED BY OWNER.
- PROVIDE EXCAVATION AS REQUIRED BY DRAWINGS. SOIL BEARING STRENGTH TO BE MINIMUM
- CONTRACTOR TO LAYOUT PARTITIONS AND ALL ROUGH OPENINGS FOR ARCHITECT/OWNER TO REVIEW FOR DESIGN INTENT. DO NOT PROCEED WITH INSTALLATION OF STUDS WITHOUT THIS REVIEW APPROVAL. CONTRACTOR SHALL COORDINATE AND VERIFY CONDITIONS TO ENSURE PROPER FIT. REVIEW FOR DESIGN INTENT DOES NOT RELEASE CONTRACTOR FROM THE RESPONSIBILITY TO MAINTAIN CRITICAL DIMENSIONS AND CLEARANCES.
- NO BACKFILLING OR ROUGH GRADING SHALL BE DONE UNTIL THE FIRST FLOOR DECK IS COMPLETELY INSTALLED.

- ALL DIMENSIONS ARE TO ROUGH STUD FACE, CONCRETE OR C.M.U. FACE, AND EXTERIOR
- COORDINATE FINISH WALL DIMENSIONS WITH MILLWORK AND FURNITURE SYSTEM DIMENSIONS AS
- REMOVE ALL CONSTRUCTION DEBRIS FROM PROPERTY AND PROVIDE DAILY CLEANUP TO SITE
- CONTRACTOR TO PROVIDE FINAL GRADING AND GRADE EARTH AWAY FROM FROM ALL PARTS OF NEW CONSTRUCTION AND MAINTAIN 8" (MIN) DISTANCE FROM TOP OF FINAL GRADE TO WOOD
- VERIFY WITH OWNER CONSTRUCTION STAGING AND CONSTRUCTION DELIVERY LOCATIONS.
- PROVIDE ALL WALL, BASE, CAP, THROUGH-WALL, COUNTER FLASHINGS, GUTTERS AND DOWNSPOUTS ETC. AS REQUIRED TO PREVENT THE ENTRANCE OF MOISTURE AND WATER.
- 17) BUILDING SHALL BE SHEATHED WITH (MIN.) WEATHER RESISTIVE BARRIER AND 15# ASPHALT-IMPREGNATED FELT.

THE MIDPOINT WITH SOLID BLOCKING.

- WINDOW SIZES ARE BASED UPON ANDERSON WINDOWS. ALL GLAZING OVER 9 SQUARE FEET AND/OR WITHIN 18" OF FLOOR AND IN HAZARDOUS LOCATIONS SHALL BE TEMPERED.
- METAL HEAD FLASHING SHALL BE INSTALLED IN ALL WINDOWS. MINIMUM 6" WIDE FLASHING TAPE SHALL BE INSTALLED AROUND ALL WINDOWS. FOLLOW ALL MANUF. RECOMMENDATION.
- ALL STUD FRAMED WALLS GREATER THAN 8'-6" VERTICALLY SHALL BE LATERALLY BRACED AT
- INTERIOR PARTITIONS SHALL RECEIVE 1/2" (MIN.) GYPSUM DRYWALL. GARAGE WALLS AND
- CEILINGS SHALL RECEIVE 5/8" (TYPE"X") FIRE RATED GYPSUM DRYWALL,

- 22) ALL NEW WOODWORK TO BE PAINT GRADE FINGER JOINTED PINE (UNO) INSTALLED, SANDED AND READY FOR FINISH. VERIFY WITH OWNER BEFORE PURCHASE, ANY SUBSTITUTIONS IN FINISH WOODWORK MATERIALS, (IE HARD WOODS, STAIN GRADE, ECT.).
- 23) PROVIDE ALL REQUIRED CEMENTITIOUS BACKER-BOARD AS REQ'D AT ALL AREAS OF MARBLE/GRANITE/ TILE WORK.

BETWEEN FINISH GRADE AND SHEATHING OR SIDING.

OF 30# ASPHALT-IMPREGNATED FELT.

- 24) VERIFY ALL CARPETING AND PADDING WITH OWNER. PROVIDE SAMPLES AS REQUIRED.
- 25) FILL, SPACKLE (3-COATES), SAND AND PRIME/PAINT ALL NEW DRYWALL WORK IN PREPARATION FOR FINAL FINISH.
- 26) NEW PAINTING TO BE M.A.B, OR APPROVED EQUAL, ACRYLIC LATEX. ALL NEW INTERIOR AND EXTERIOR WALLS AND CEILINGS TO RECEIVE ONE COAT PRIMER AND MINIMUM 2 COATS FINISH.
- 27) ALLOW A MINIMUM OF 8" BETWEEN THE TOP OF FOUNDATION AND GRADE AND A MINIMUM OF 6"
- 28) PORTLAND CEMENT STUCCO SHALL CONSIST OF (3 COATS) SCRATCH, BROWN AND FINISH COATS (MIN 7/8" THK.) APPLIED OVER (MIN.) 2.4 SELF FURRING GALV. WIRE LATH AND TWO LAYERS
- 29) MASONRY AND STONE VENEERS SHALL BE ANCHORED TO SHEATHING WITH GALVANIZED CORRUGATED METAL TIES AT 32" O.C. HORIZONTALLY AND 16" O.C. VERTICALLY, FLASHING SHALL EXTEND BELOW MASONRY OR STONE AT ALL SILLS; WEEP HOLES SHALL BE PROVIDED AT 2'-0" O.C. AT BASE OF CAVITY AND 6" ABOVE GRADE.
- 30) NO STRUCTURAL CHANGES SHALL BE MADE WITHOUT PRIOR APPROVAL BY THE ARCHITECT.
- 31) ALL SMOKE DETECTORS SHALL BE INTERCONNECTED. ALL DETECTORS SHALL HAVE A PRIMARY 120 VOLT SUPPLY AND A SECONDARY SYSTEM CONSISTING OF A BATTERY BACK-UP.


- 32) ALL ELECTRICAL WORK TO BE DESIGN BUILD ELECTRICAL CONTRACTOR TO BE LICENSE AND INSURANCE WITH THE LOCAL MUNICIPALITY AND THE STATE AS REQUIRED. ELECTRICAL CONTRACTOR TO OBTAIN ALL PERMITS.
- 33) ELECTRICAL CONTRACTOR TO VERIFY CAPACITY OF EXISTING INCOMING SERVICE TO SERVE EXISTING AND NEW SPACES/ROOMS AS INDICATED. PROVIDE ALL ATTENDANT WIRING, PANELS,
- 34) ELECTRICAL CONTRACTOR TO VERIFY FINAL NO., STYLE, COLOR, TYPES AND LOCATIONS OF ALL OUTLETS, SWITCHES, FIXTURES, ETC., WITH OWNER PRIOR TO ORDERING/INSTALLATION.
- 35) ALL MECHANICAL WORK TO BE DESIGN BUILD MECHANICAL CONTRACTOR TO BE LICENSE AND INSURANCE WITH THE LOCAL MUNICIPALITY AND THE STATE AS REQUIRED. HVAC CONTRACTOR TO OBTAIN ALL PERMITS. OWNER TO APPROVE ALL NEW GRILLE LOCATIONS AND STYLES PRIOR TO INSTALLATION (INCLUDING ALL ATTENDANT EQUIPMENT LOCATIONS).
- ALL PLUMBING WORK TO BE DESIGN BUILD ELECTRICAL CONTRACTOR TO BE LICENSE AND INSURANCE WITH THE LOCAL MUNICIPALITY AND THE STATE AS REQUIRED. PLUMBING CONTRACTOR TO OBTAIN ALL PERMITS.
- PLUMBING CONTRACTOR TO EXTEND ALL PLUMBING LINES AS REQUIRED FOR ALL NEW FIXTURES. SCOPE OF WORK TO INCLUDE ALL HOT AND COLD WATER FEEDS, WASTE PIPES OUT, STACK \$ VENTS, SETTING OF FIXTURES, AND ANY AND ALL HOOK-UPS/TIE-INS AS REQUIRED.

Betzwood

523 Kimberton Road, Suite 11B Phoenixville, PA 19460 tel. (610) 917-8831 fax (610) 917-8836 email mail@betzwood.com

> Robin J. Kohn, AlA Commonwealth of Pennsylvania License No. RA-11327-X

> > Contact Person: Edward (Kipp) Happ (610) 917-8831

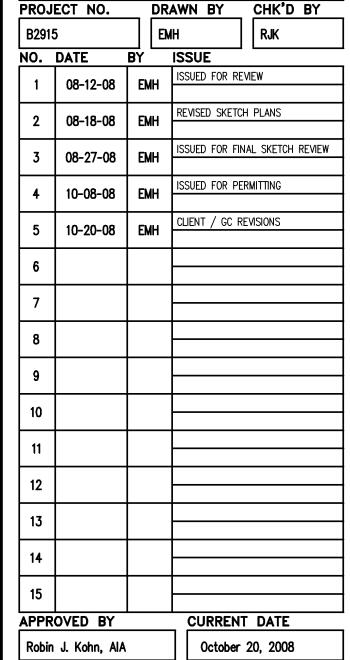

Shumaker Residence

**183 DAVIS BRIDGE ROAD** BERNVILLE, PA 19506


> PENN TOWNSHIP **BERKS COUNTY**

SHEET TITLE

TITLE SHEET

SHEET NUMBER


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Regis W. Kubit, PE

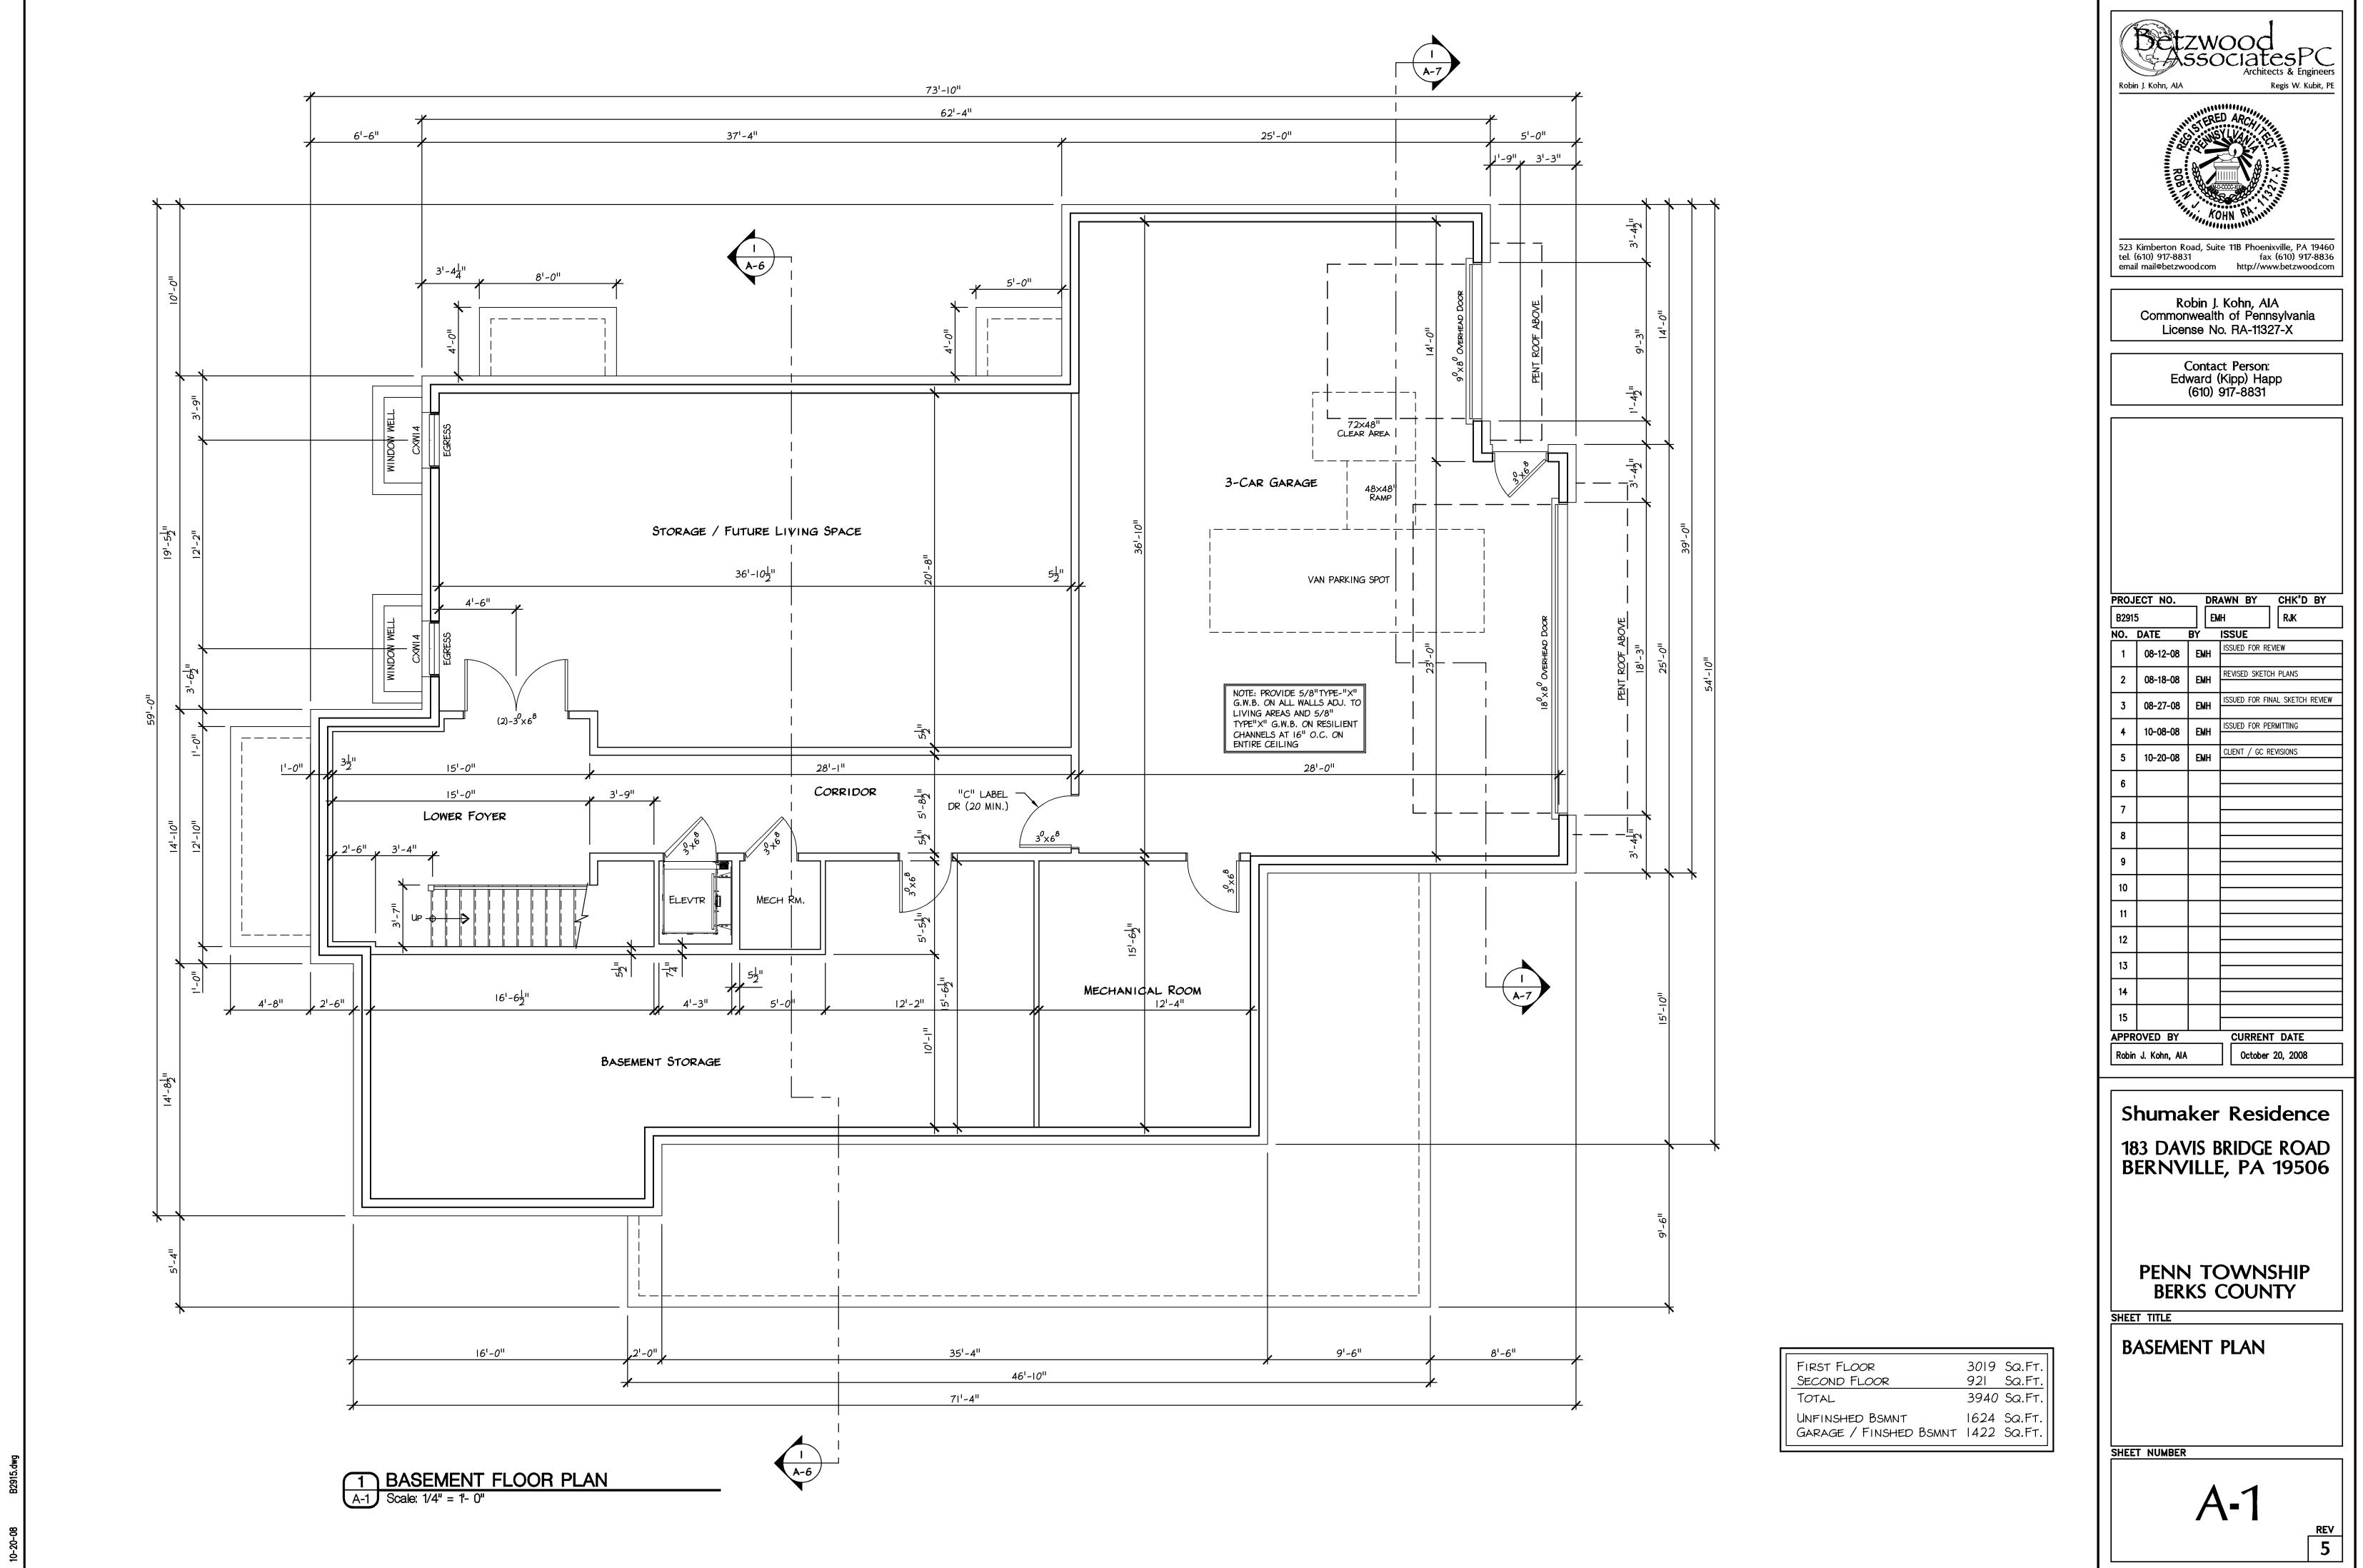ISSUED FOR FINAL SKETCH REVIEW


REV 5



AssociatesPC Regis W. Kubit, PE

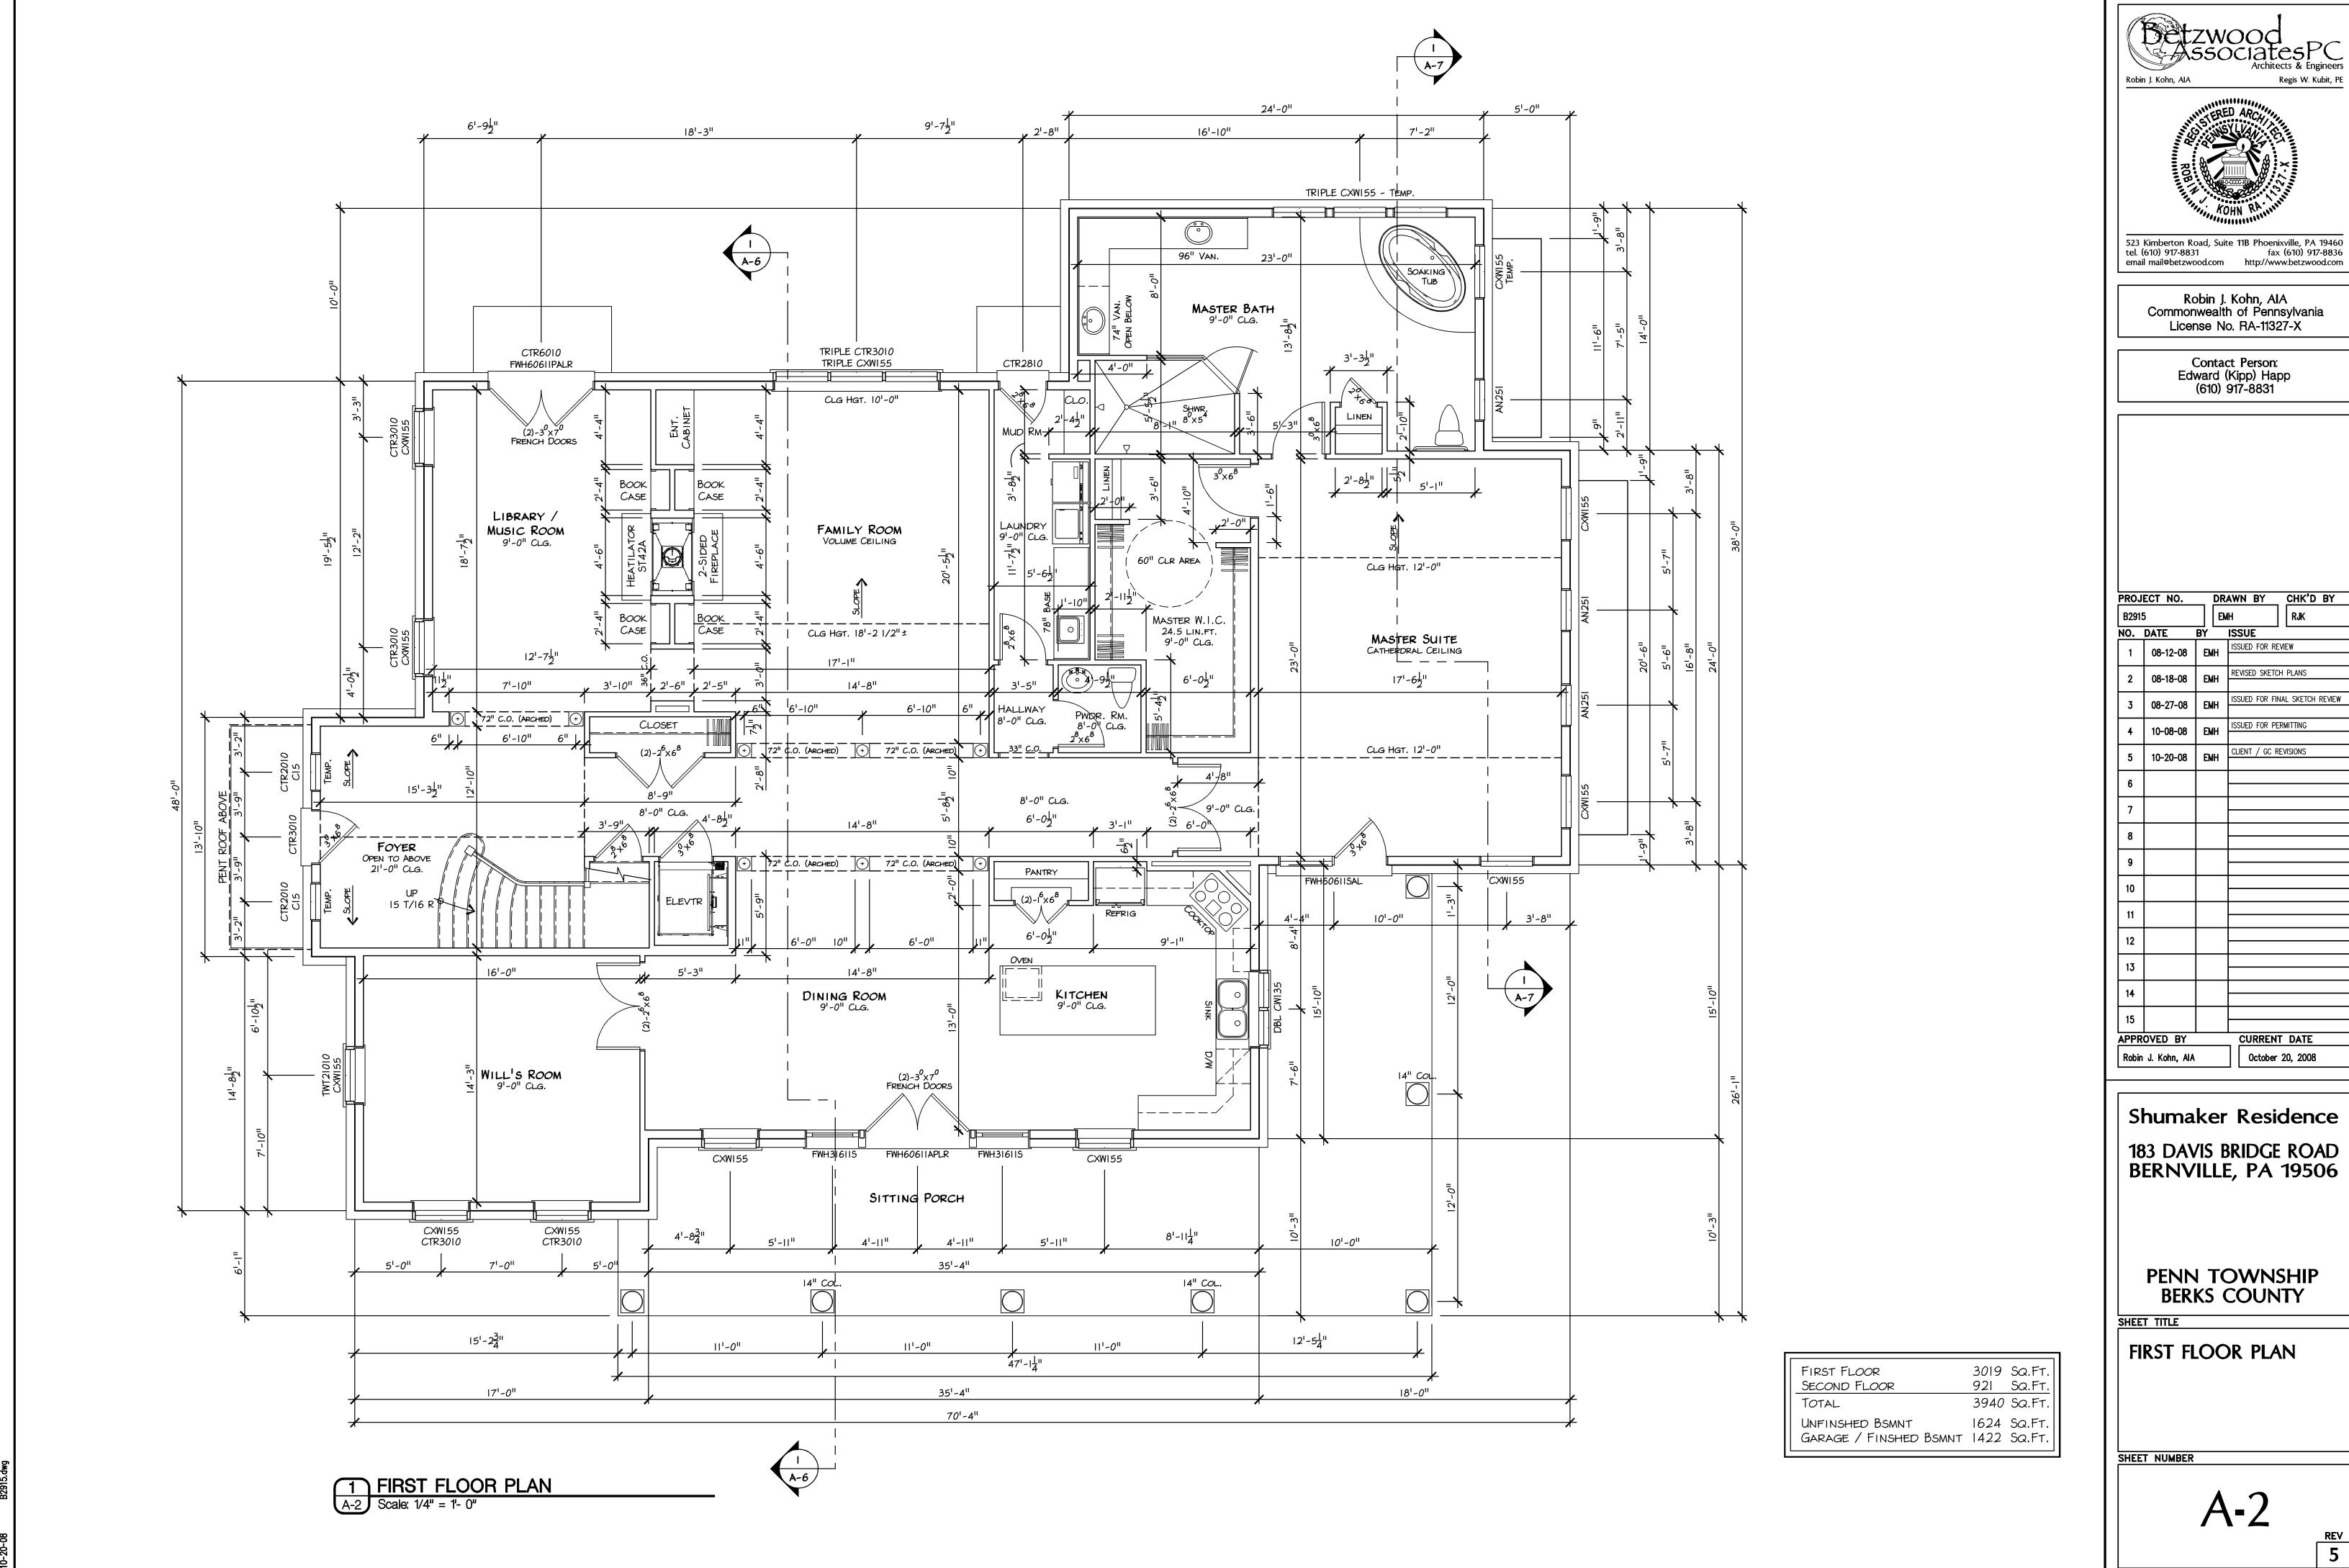SSUED FOR FINAL SKETCH REVIEW


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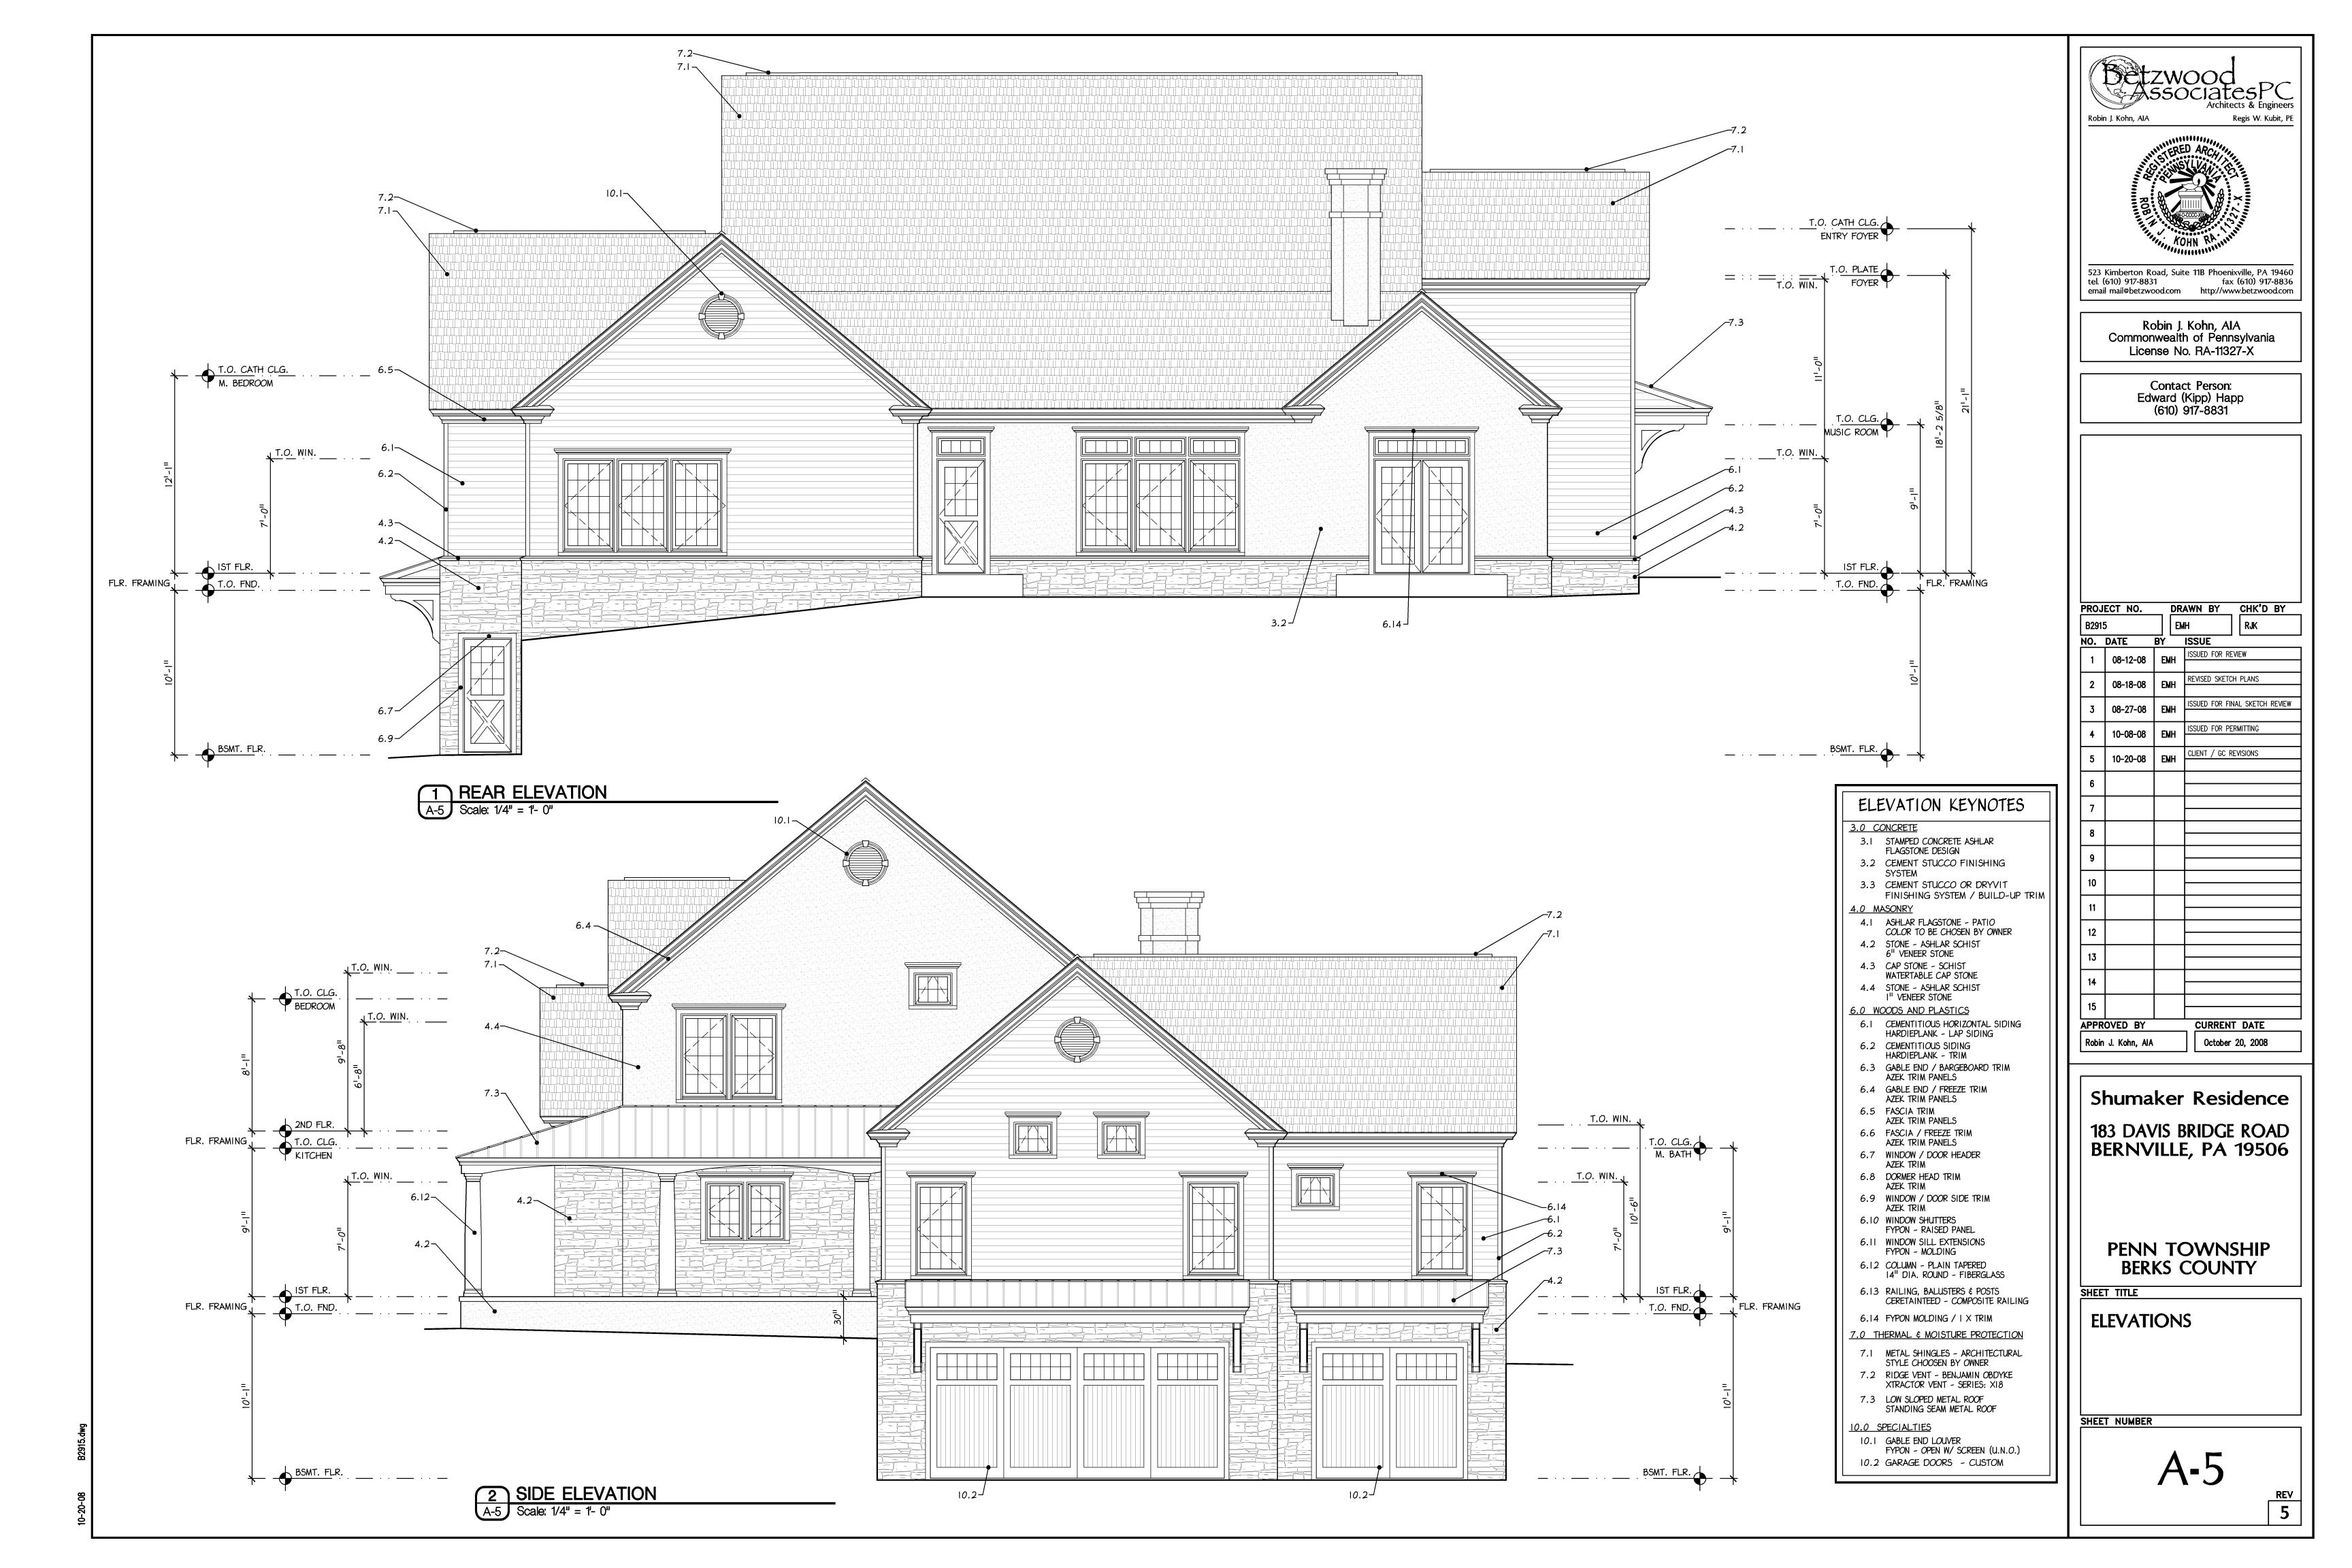


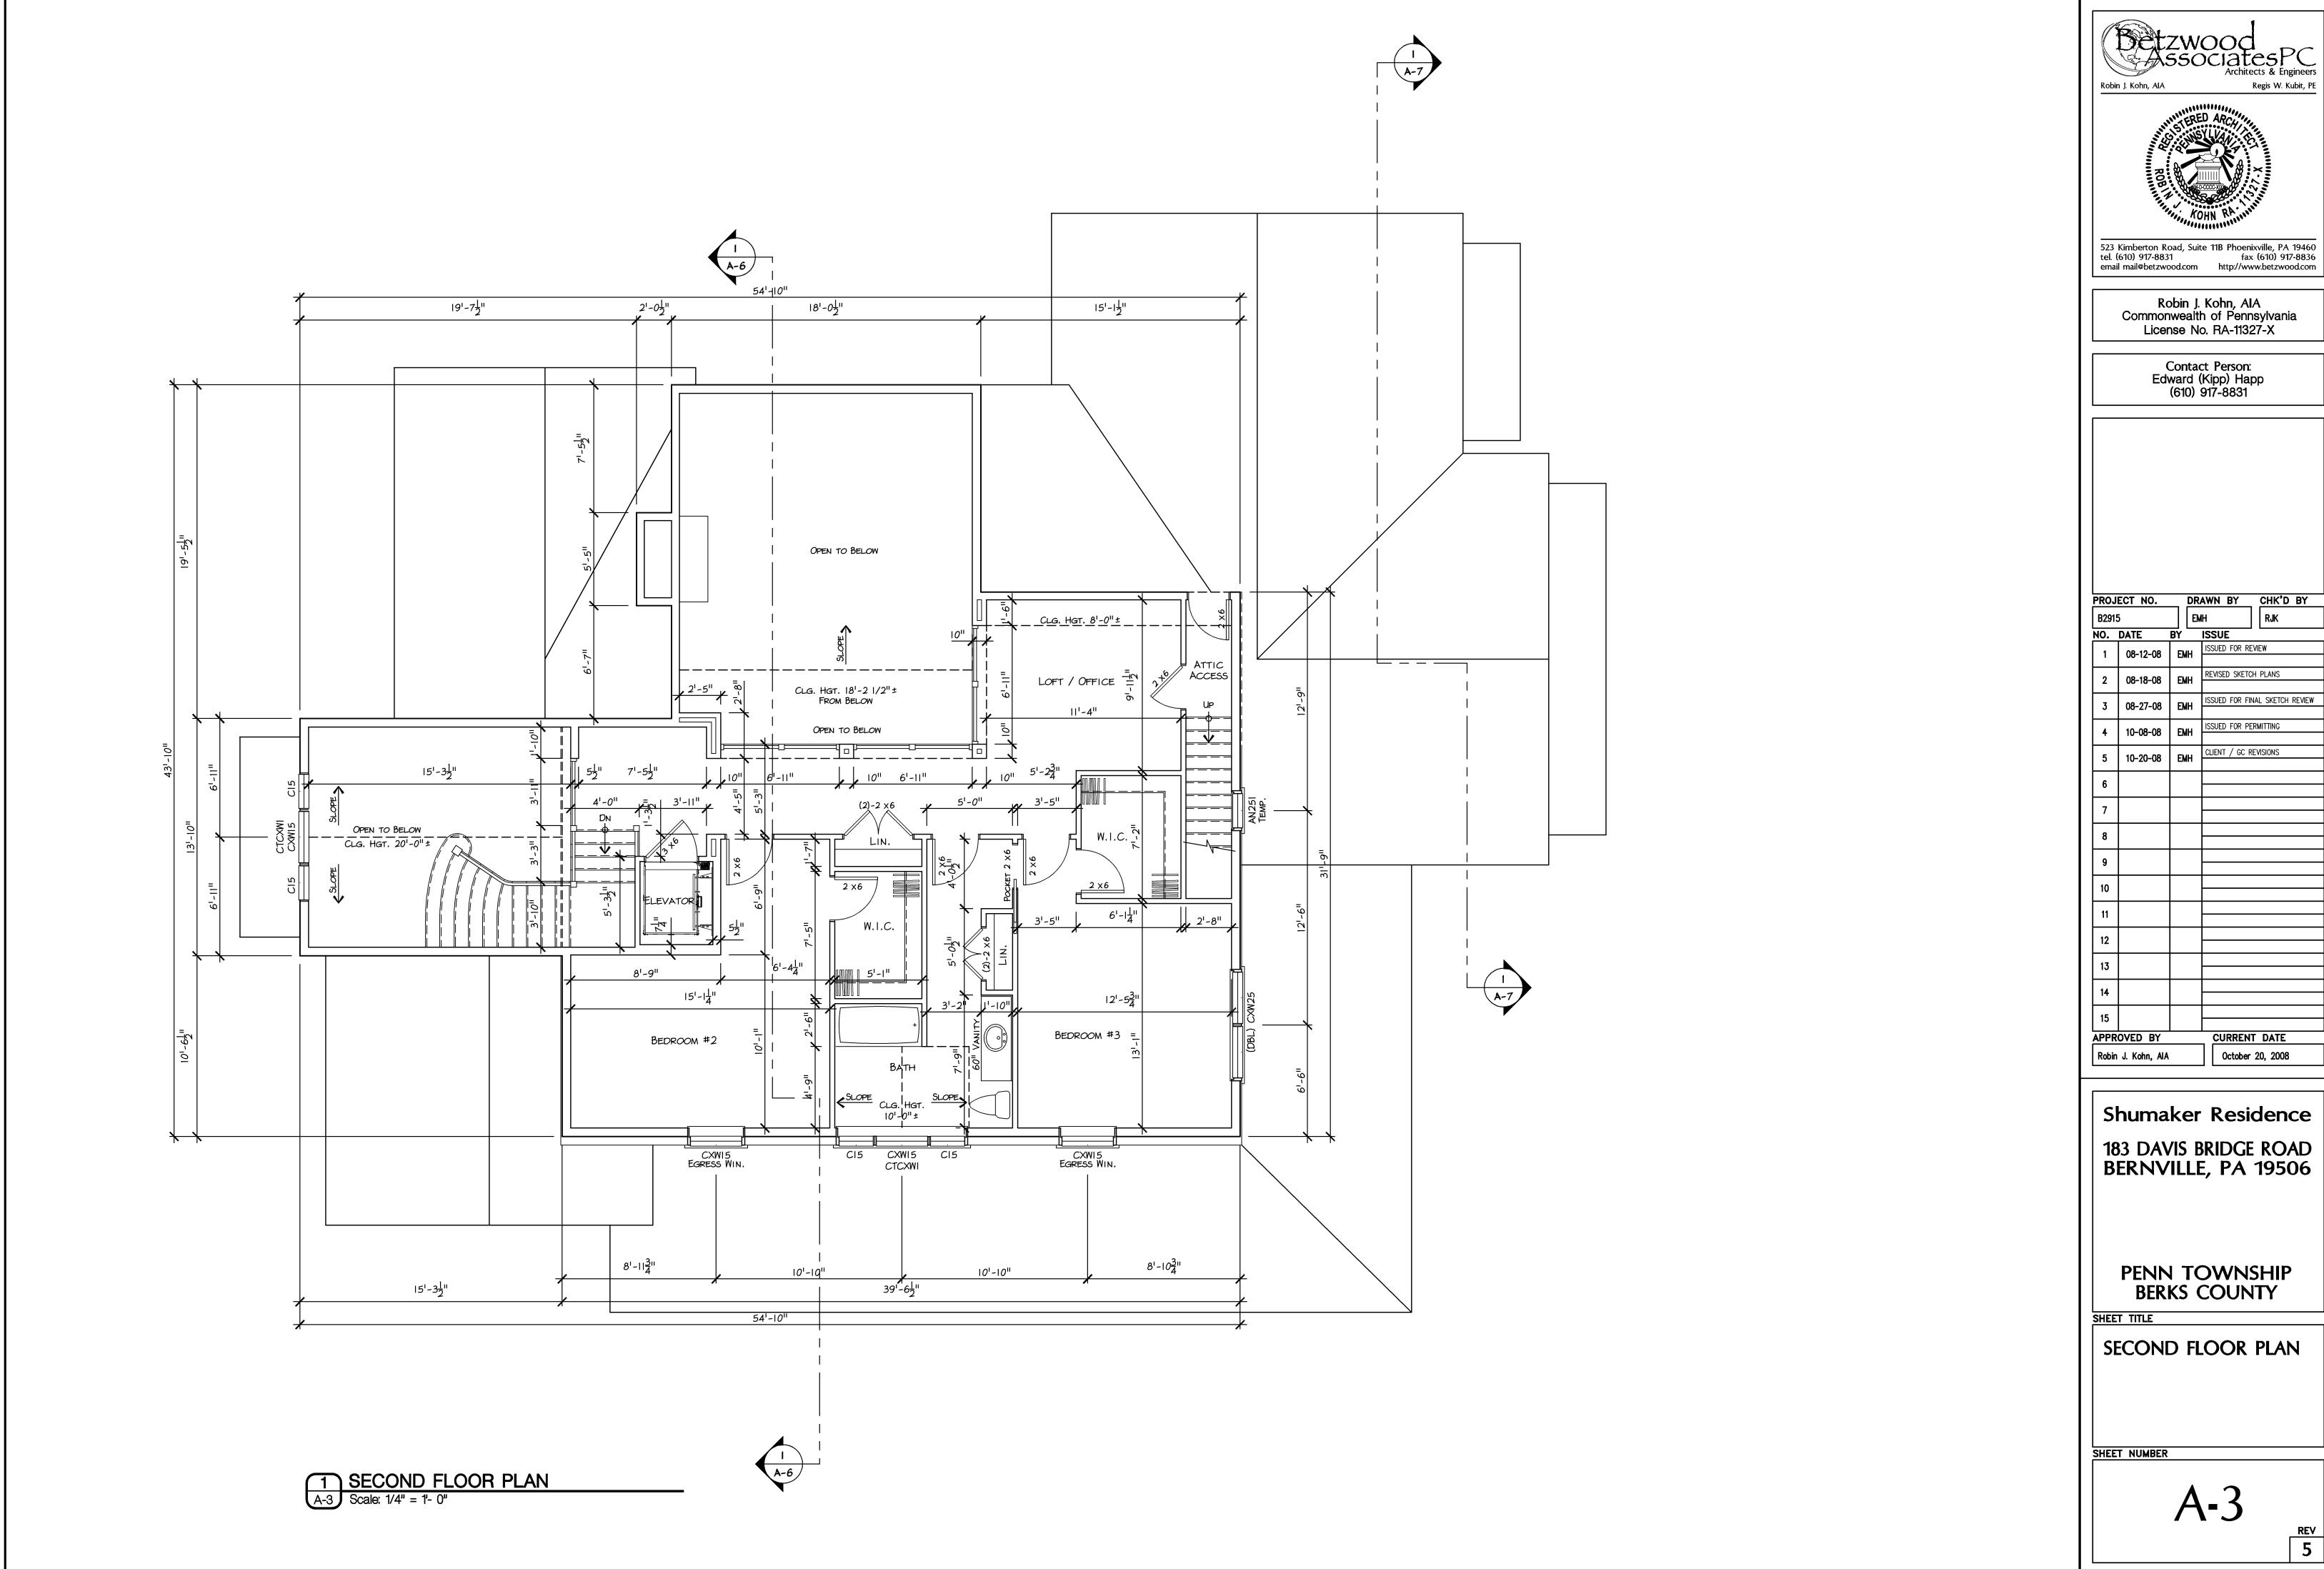
Regis W. Kubit, PE

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REV 5





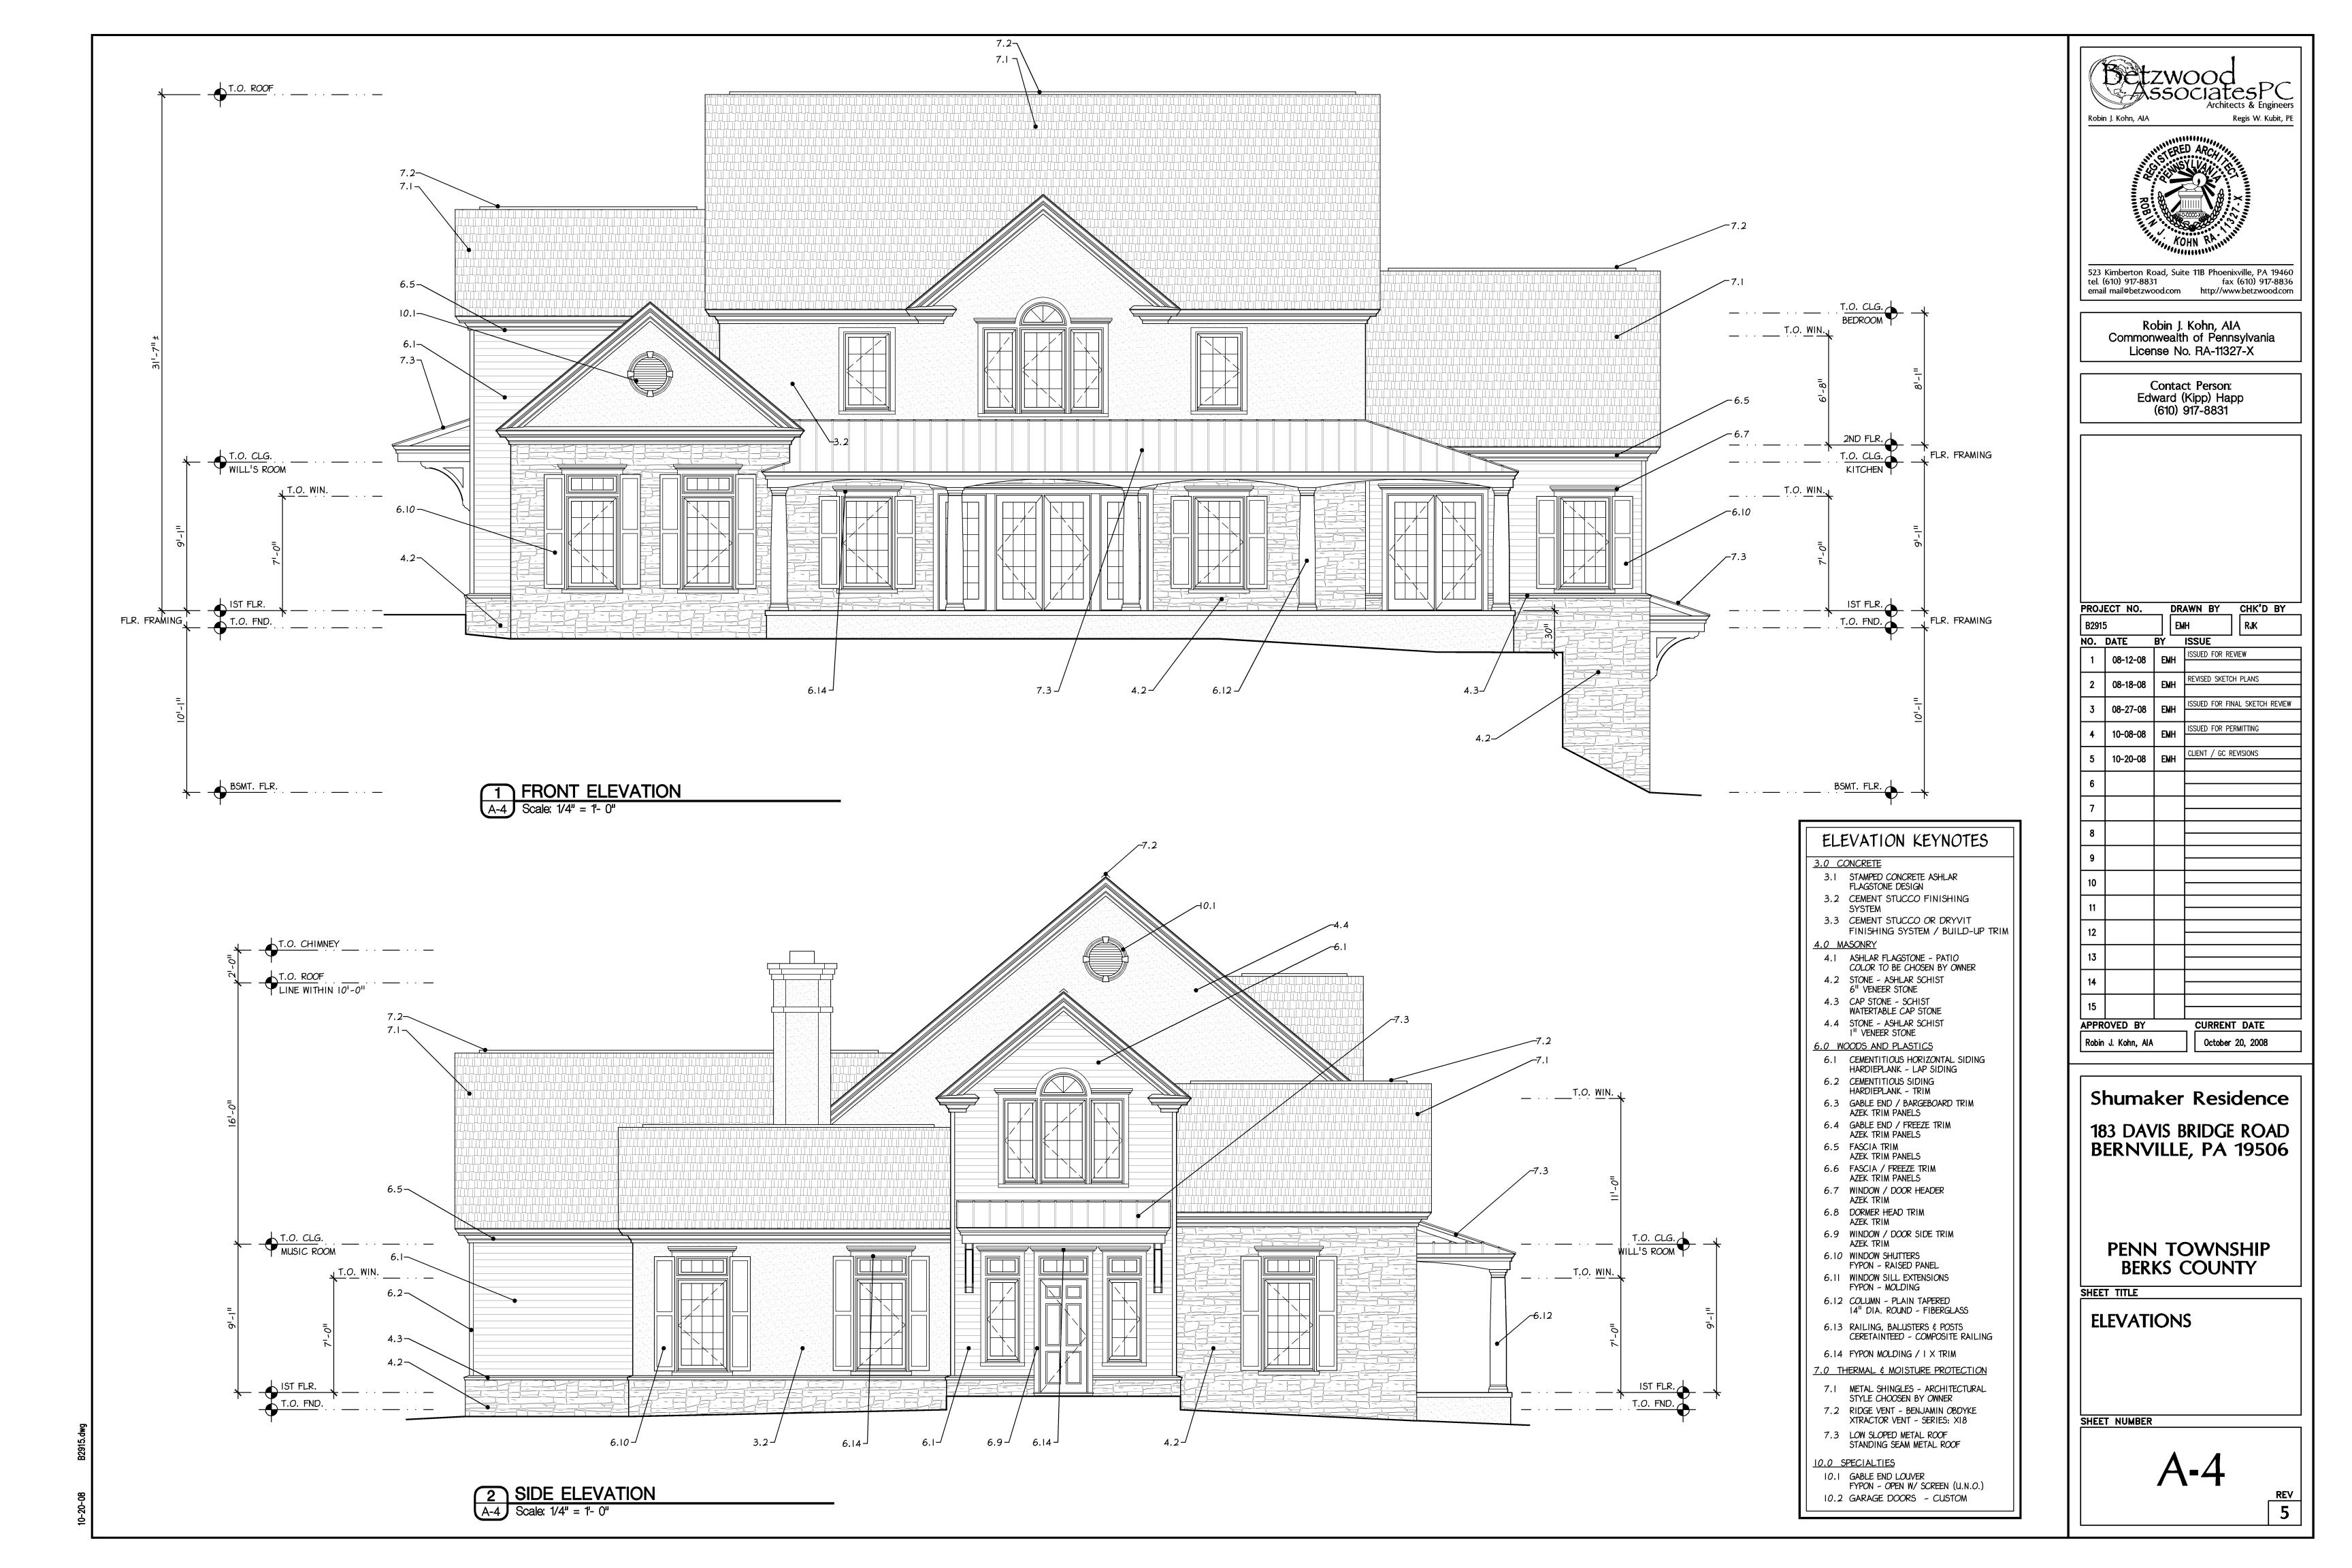
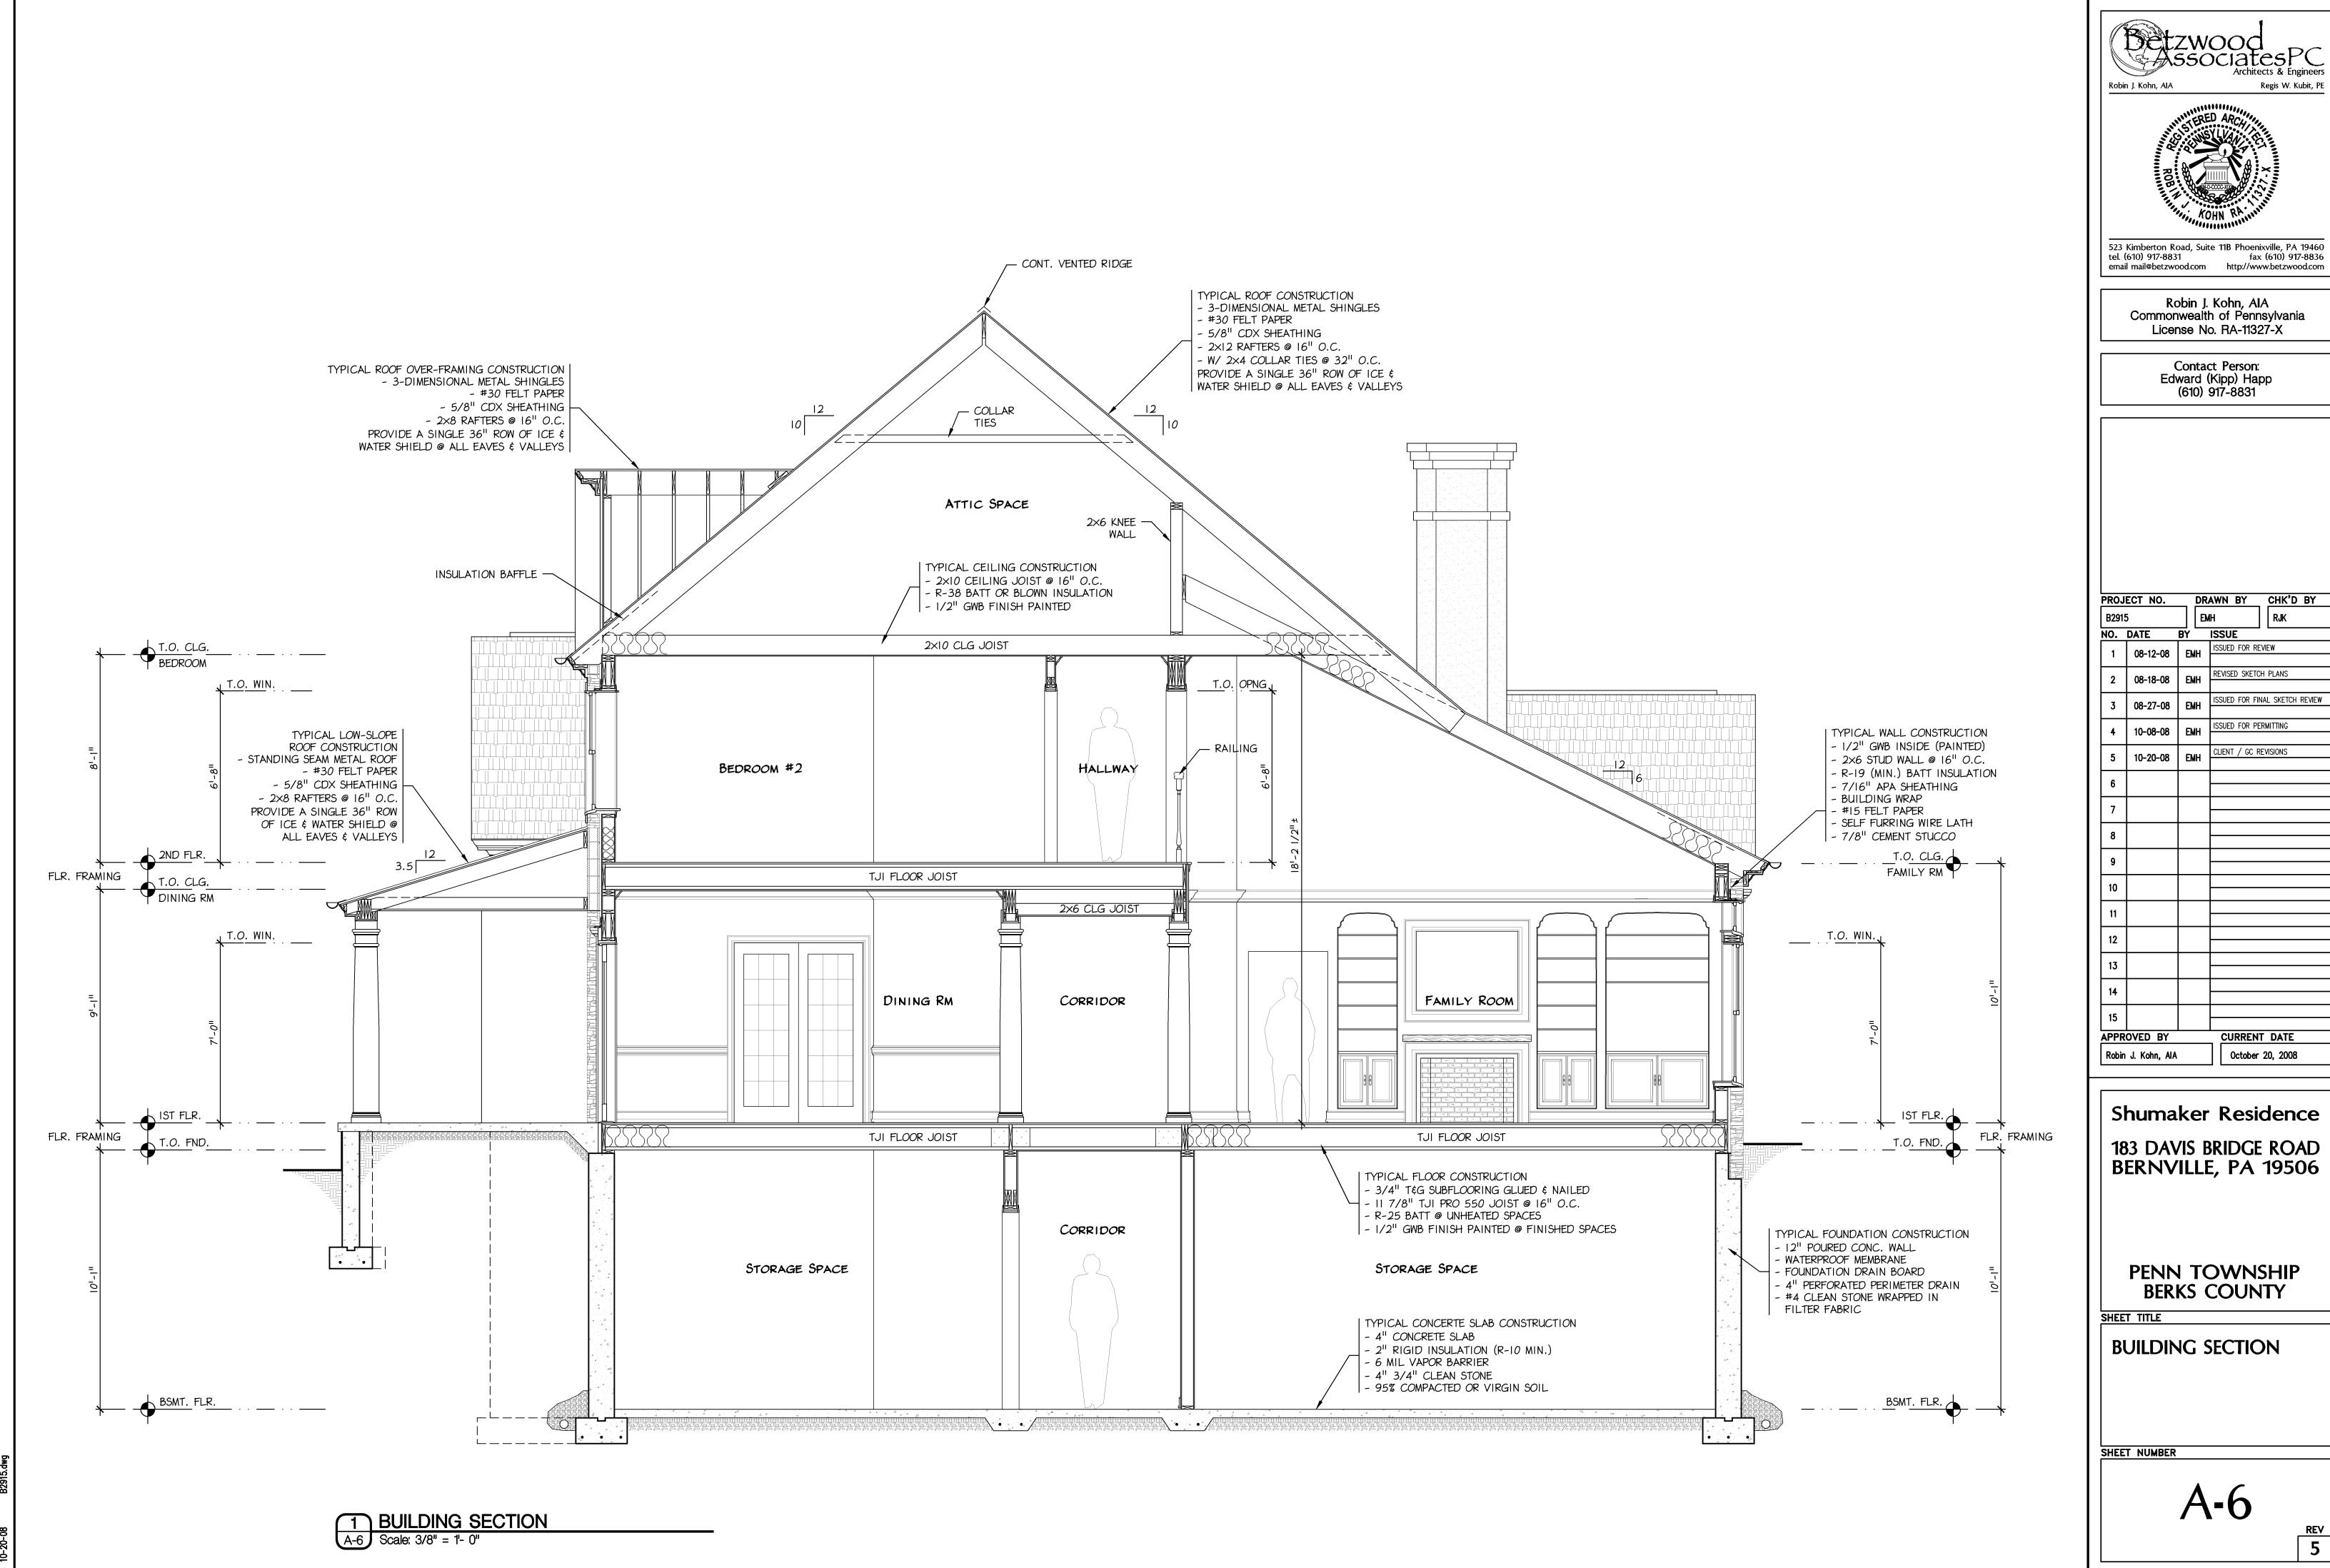
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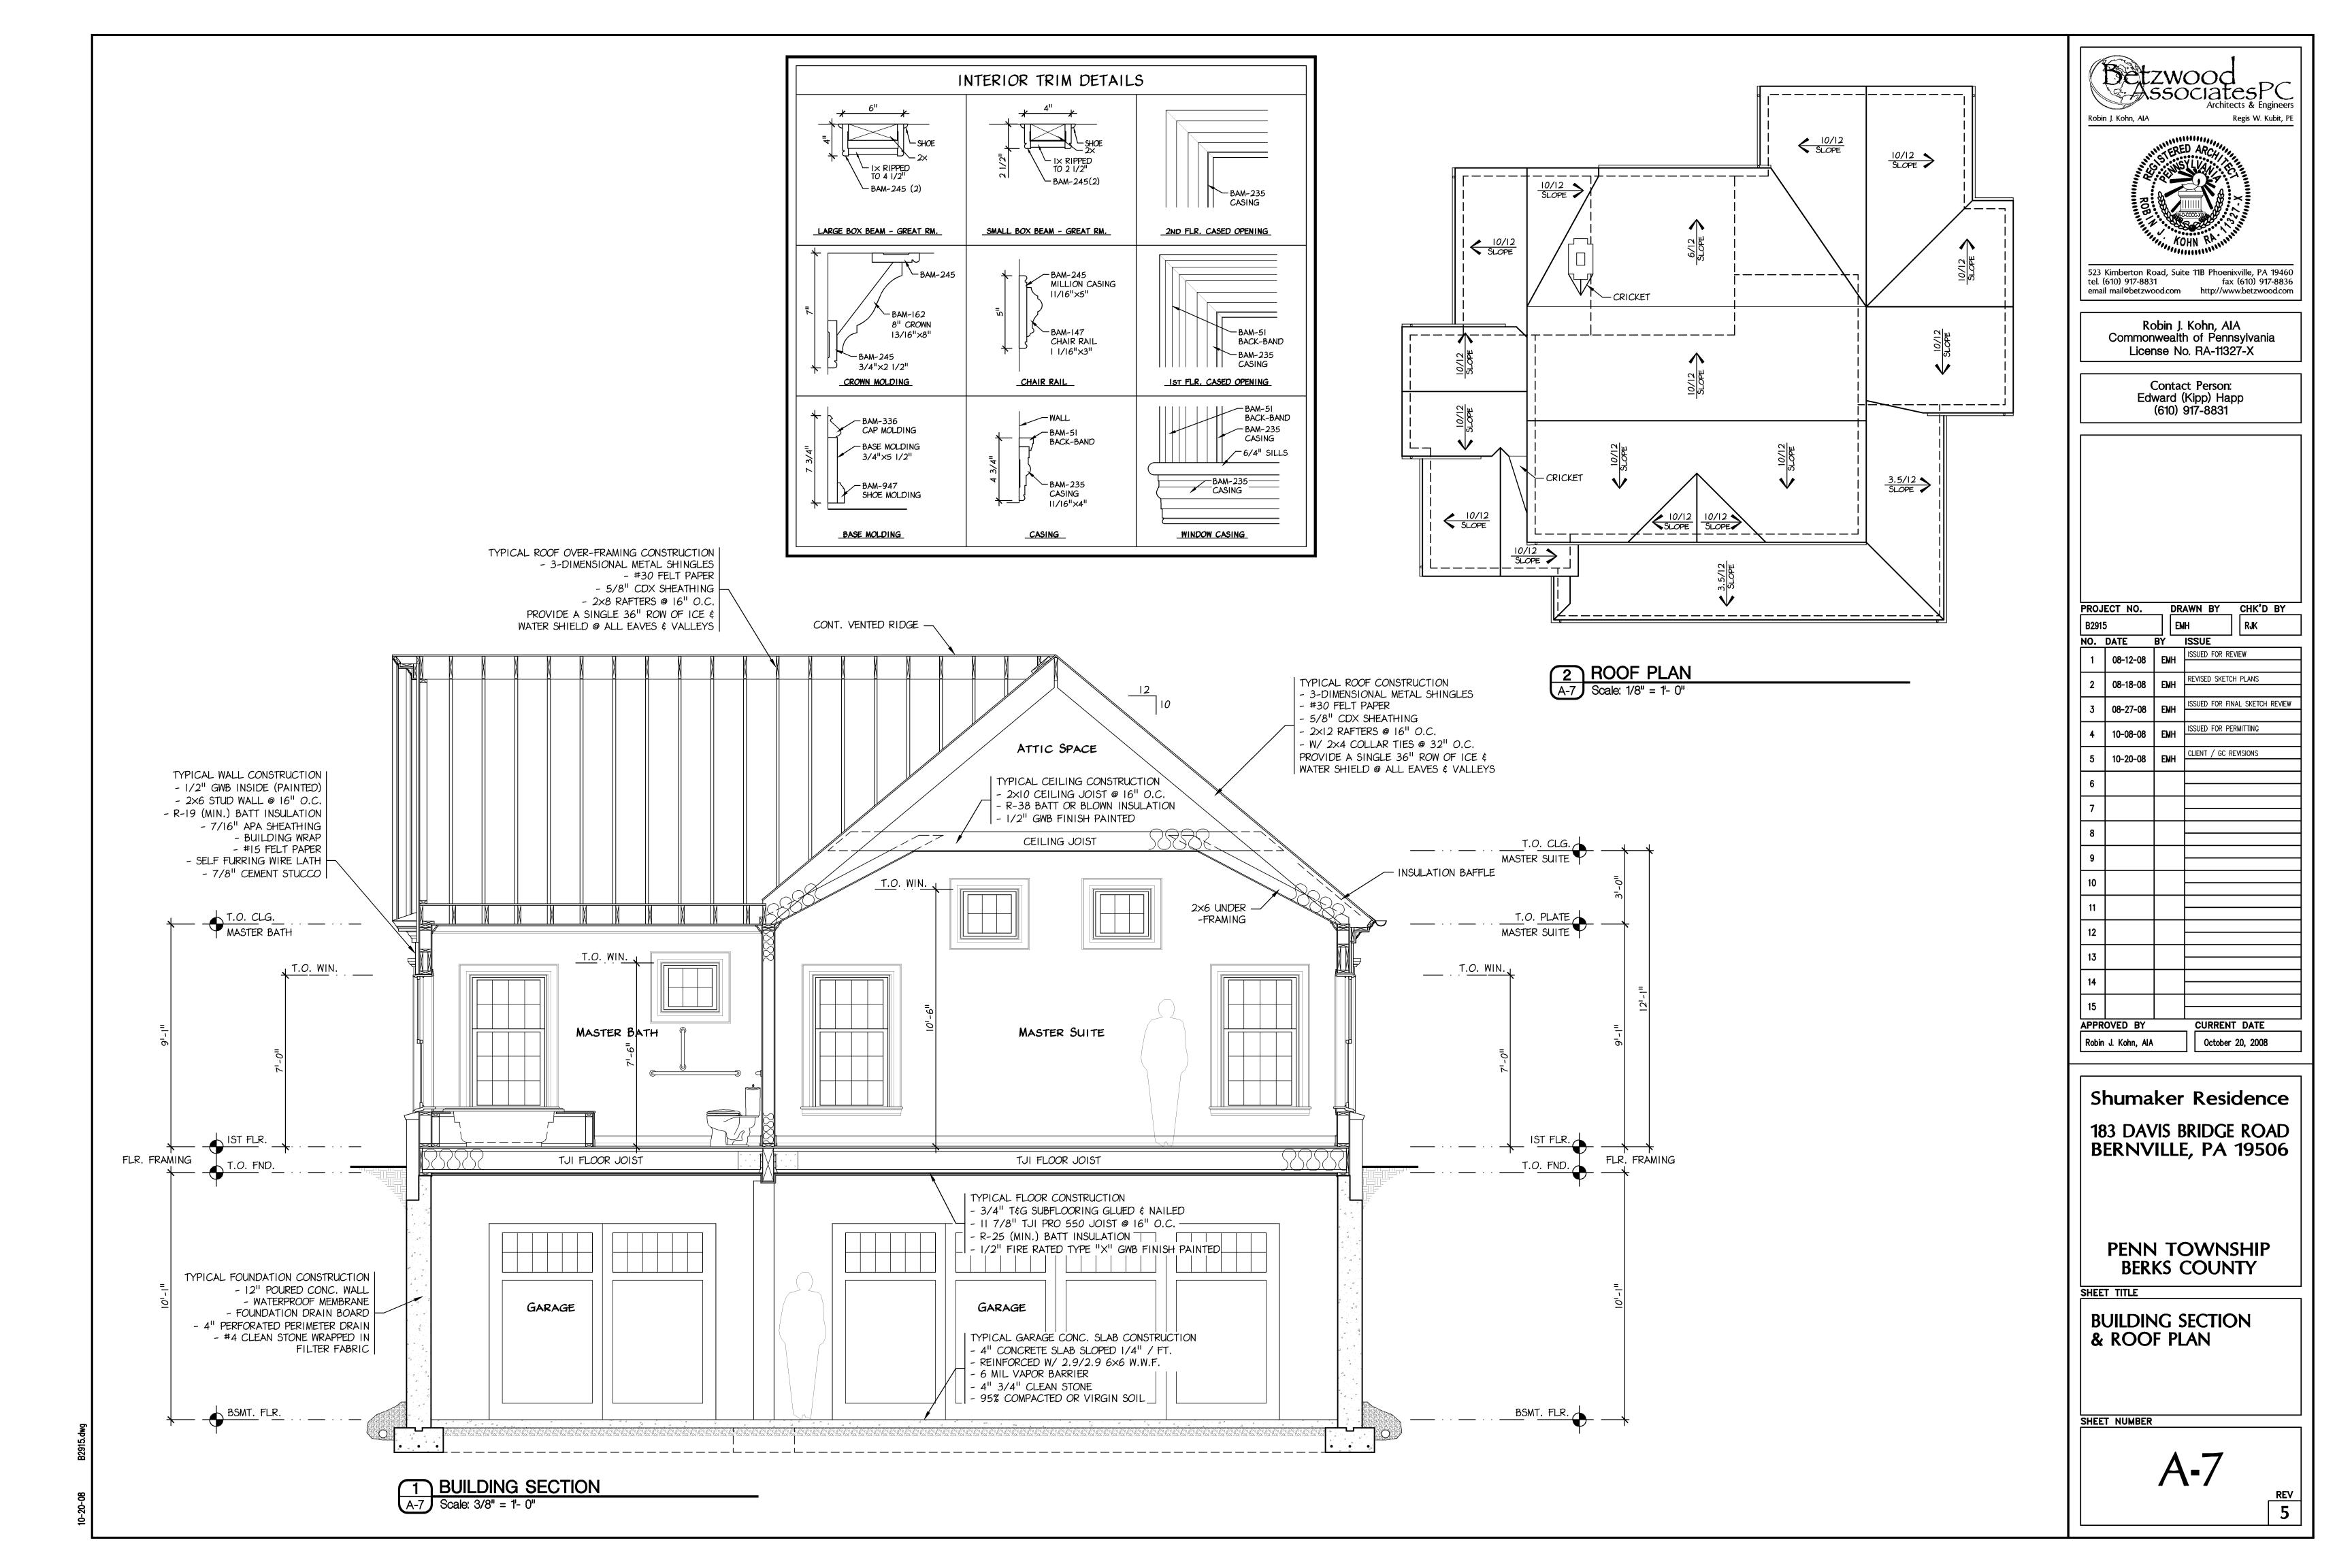
Robin J. Kohn, AIA Commonwealth of Pennsylvania License No. RA-11327-X


> Contact Person: Edward (Kipp) Happ

DRAWN BY CHK'D BY ISSUED FOR REVIEW REVISED SKETCH PLANS ISSUED FOR FINAL SKETCH REVIEW ISSUED FOR PERMITTING CLIENT / GC REVISIONS CURRENT DATE October 20, 2008

Shumaker Residence 183 DAVIS BRIDGE ROAD BERNVILLE, PA 19506

PENN TOWNSHIP



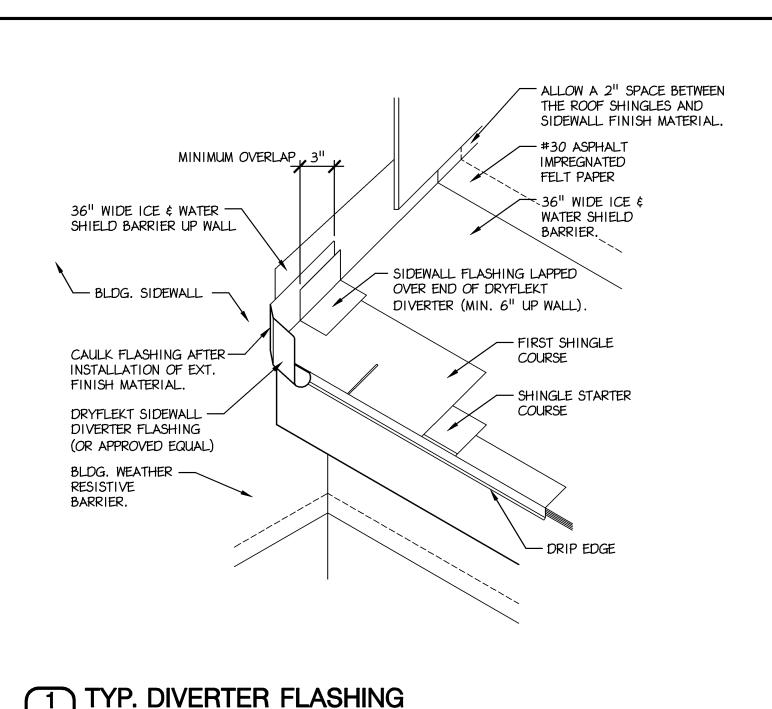


# APPLY TYVEK STUCCO WRAP OVER SHEATHING (MIN. LAP OF 3") APPLY DRIWALL RAINSCREEN 020-1 1/4" 3-DIMENSIONAL FABRIC LAP AND TAPE W/ TYVEK TAPE AT ALL JOINTS. GRADE "D" BLDG. PAPER (MIN. LAP OF 3").


- EXTERIOR SHEATHING


SHEATHING SPACED @ 1/8" ALL EDGES


TYP. WEATHER BARRIER WRAP

Scale: 3/4" = 1'- 0"

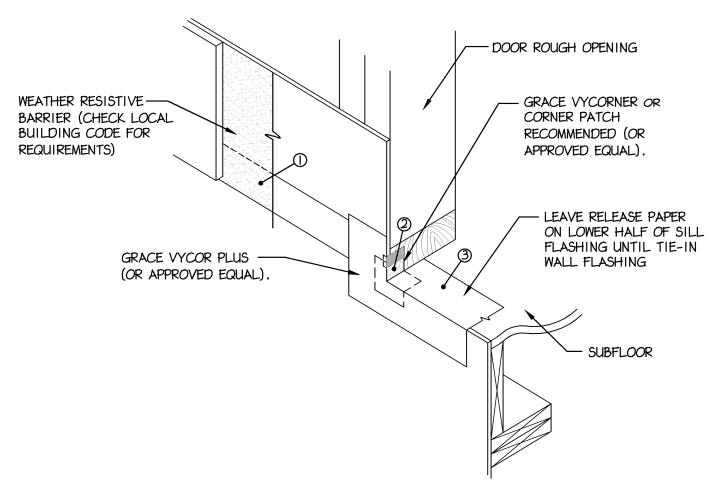

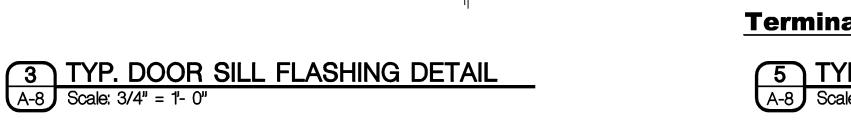

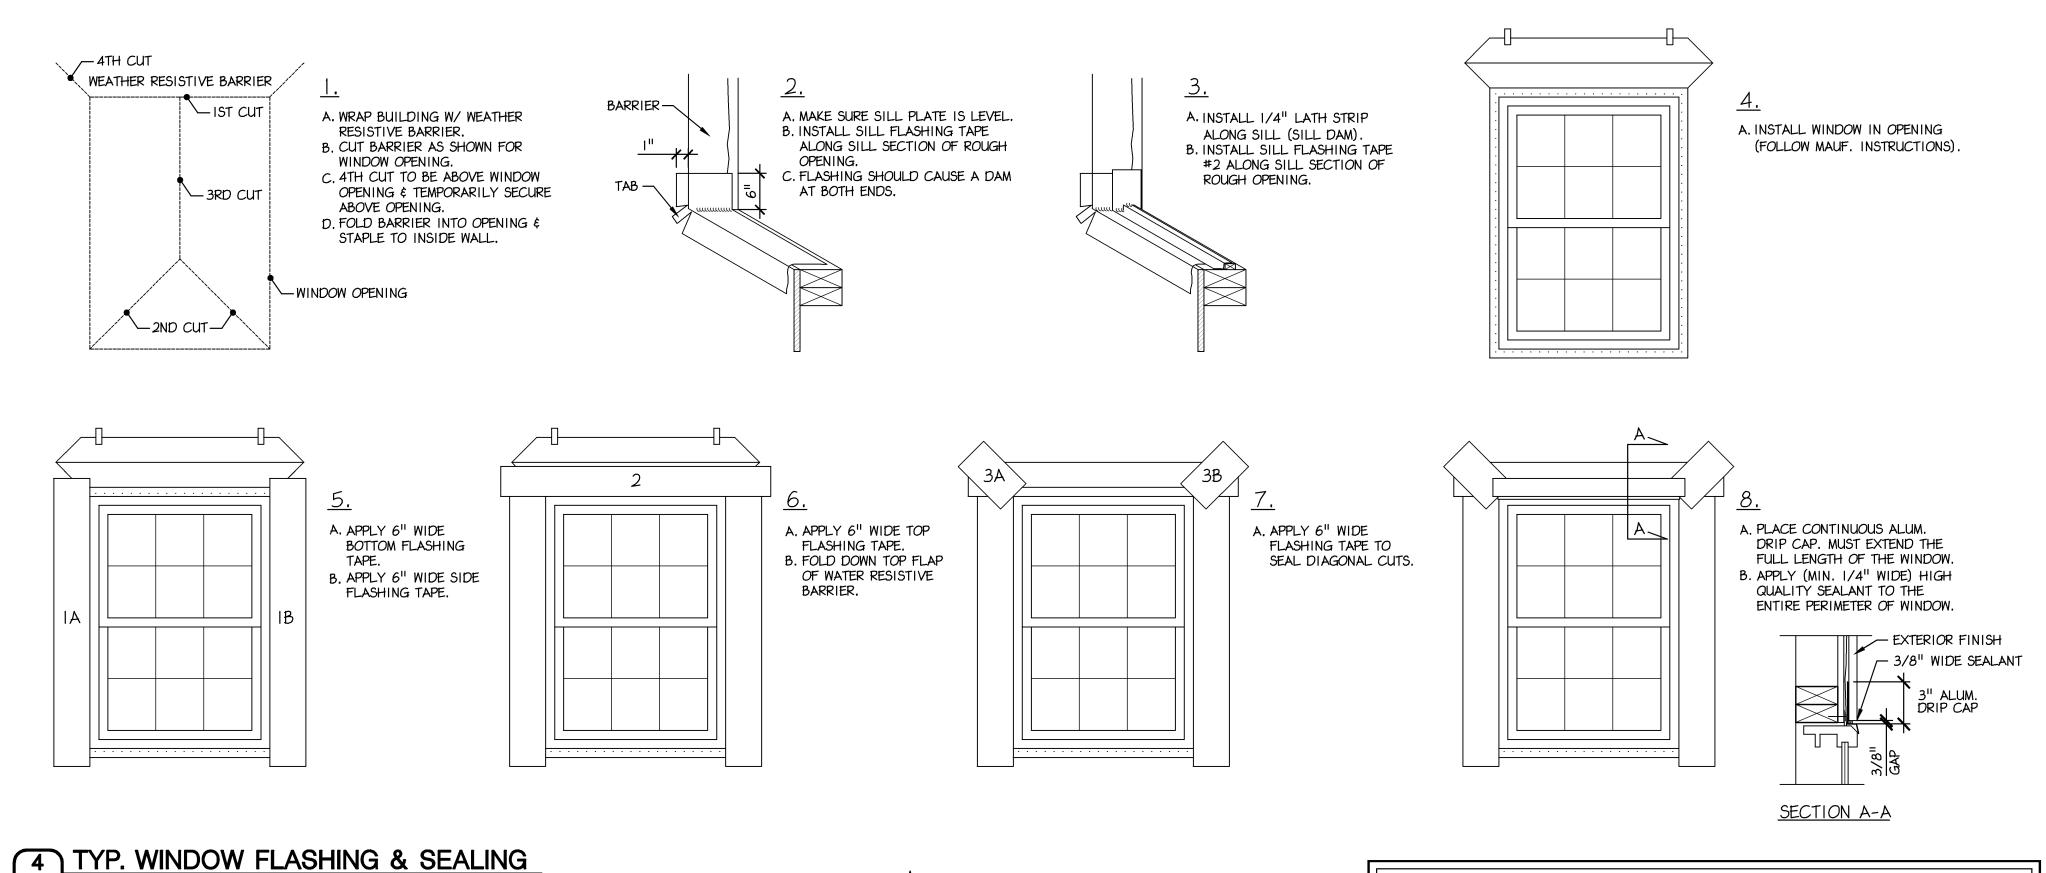

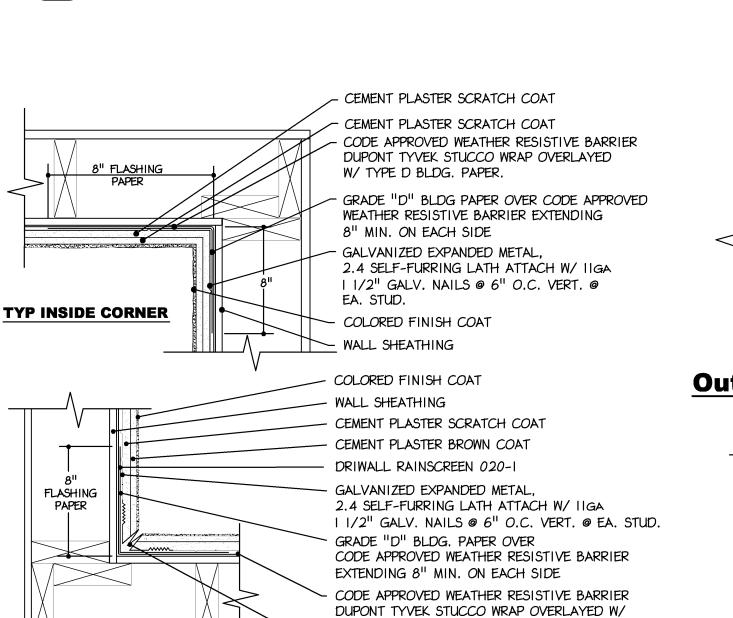


TYPE D BLDG. PAPER.

VINYL CONTROL JOINT




**INSIDE CORNER CONTROL JOINT** 

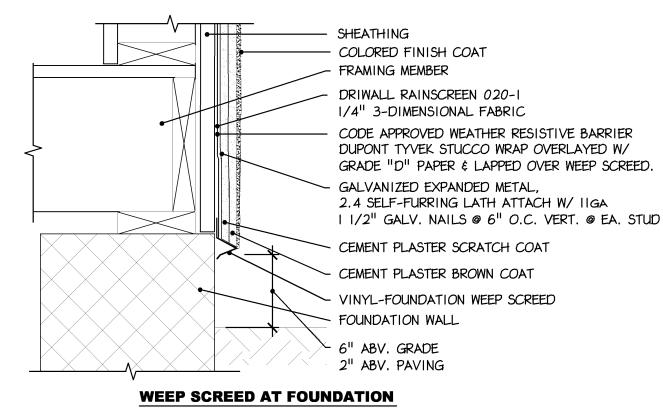


Termination at Grade

5 TYP. EXTERIOR WALL DETAIL


A-8 Scale: 3/4" = 1- 0"

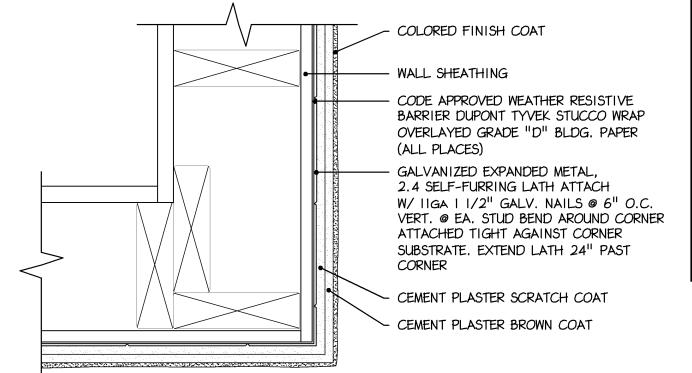

**Outside Corner** 

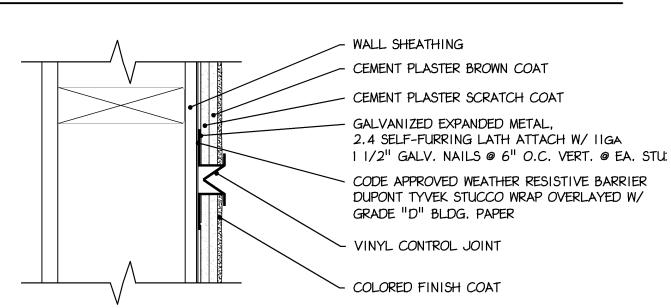


### **Control Joint Detail**

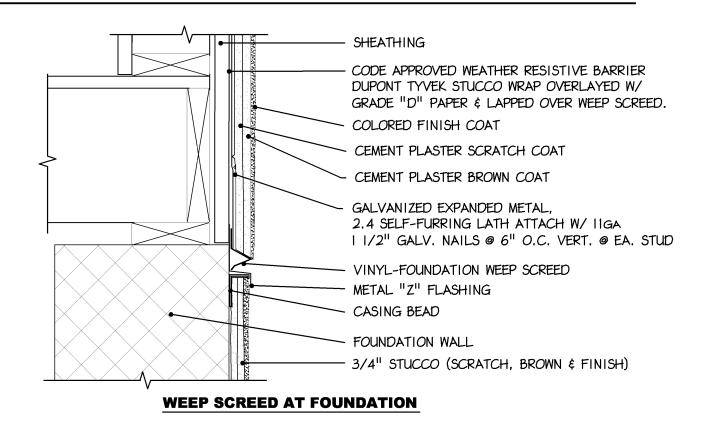


Screed Above Grade

### STUCCO NOTES:


- PLACE VERTICAL CONTROL JOINTS @ 181 CENTERS IN FLUSH WALLS.
- 2. PLACE HORIZONTAL CONTROL JOINTS AT ALL FLOOR OR CEILING LINES. CONTROL JOINTS SHOULD BREAK WALL INTO PANELS NOT EXCEEDING 144 SF.
- 3. ALL STUCCO SCREEDS AND ACCESSORIES SHALL BE VINYL.
- 4. LATH SHALL BE ATTACHED TO BUILDING FRAMING, NOT SHEATHING.
- 5. STUCCO COATS SHALL BE: 3/8" SCRATCH, 3/8" BROWN, 1/8 FINISH
- 6. SCORES IN SCRATCH COAT SHALL BE HORIZONTAL.
- 7. BROWN COAT SHOULD BE APPLIED TO SCRATCH AS SOON AS SCRATCH IS SUFFICIENTLY RIGID. 8. INSTALL CONTROL JOINT WHERE STUCCO COVERS OR INTERSECTS DISSIMILAR MATERIALS.
- 9. MOIST CURE STUCCO IN HOT OR DRY WEATHER. DO NOT USE ANTI-FREEZE ADDITIVES

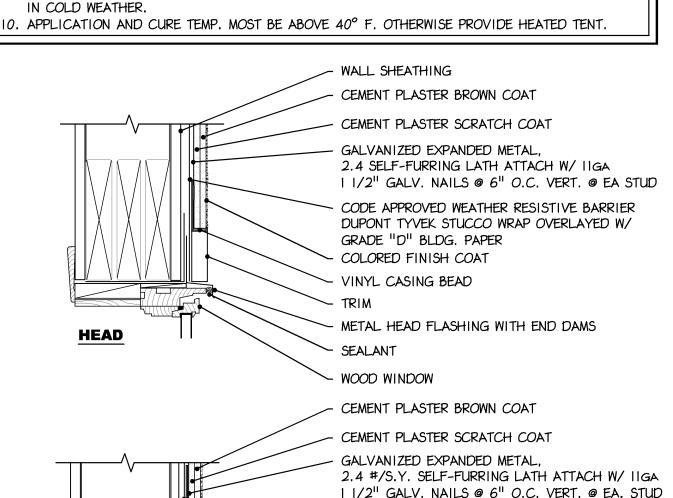

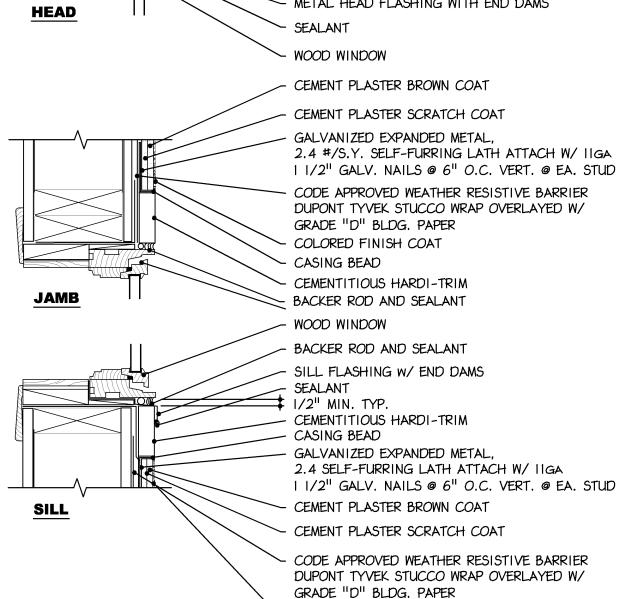

COLORED FINISH COAT

**Termination at Window** 

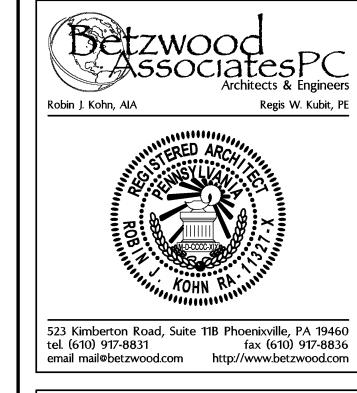

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> Contact Person: Edward (Kipp) Happ (610) 917-8831

> > DRAWN BY

CHK'D BY

Shumaker Residence 183 DAVIS BRIDGE ROAD BERNVILLE, PA 19506

PENN TOWNSHIP BERKS COUNTY


DETAILS

SHEET NUMBER

A-8

REV 5

0-00-08

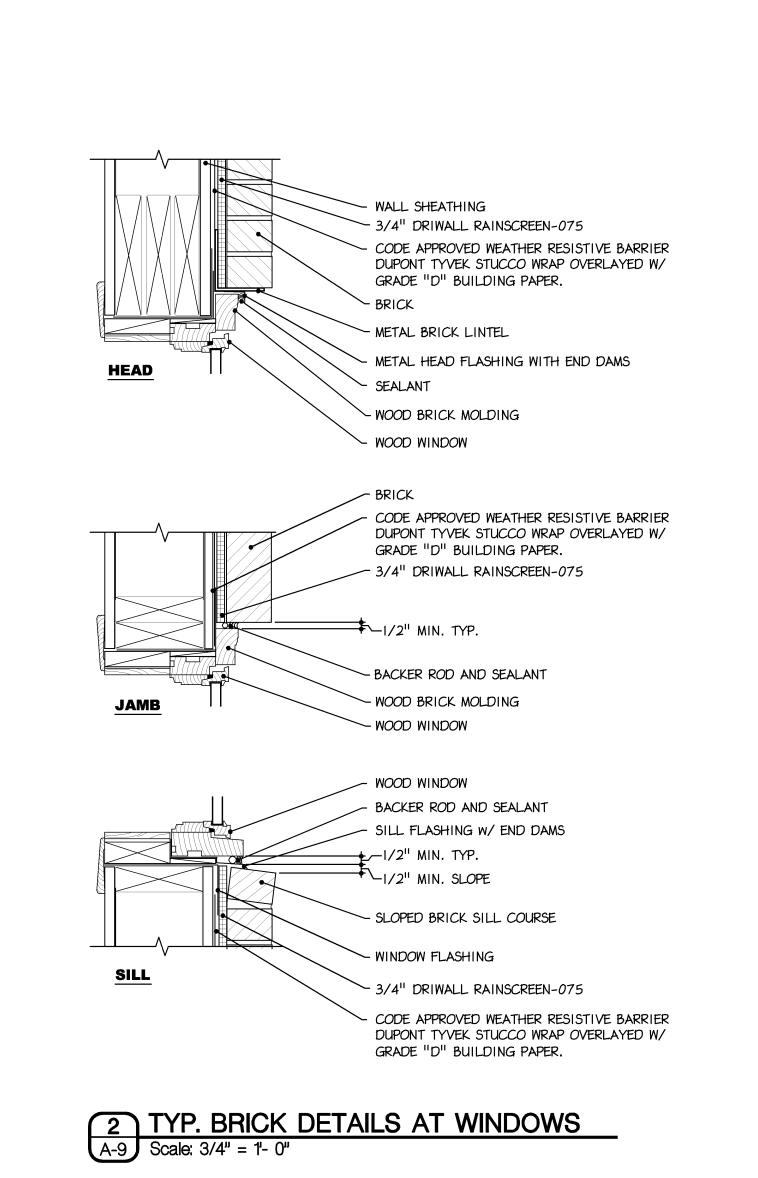

- BLDG. FRAMING

- GRADE "D" BUILDING PAPER

WEATHER RESISTIVE BARRIER

(TYVEK HOMEWRAP RECOMMENDED

OR APPROVED EQUAL). APPLY TO EXTERIOR SHEATHING

LAP AND TAPE W/ TYVEK TAPE

OVER BLDG. WRAP

(MIN. LAP OF 3").


(MIN. LAP OF 3").

AT ALL JOINTS.


- EXTERIOR SHEATHING

1 TYP. WEATHER BARRIER WRAP

A-9 Scale: 3/4" = 1'- 0"

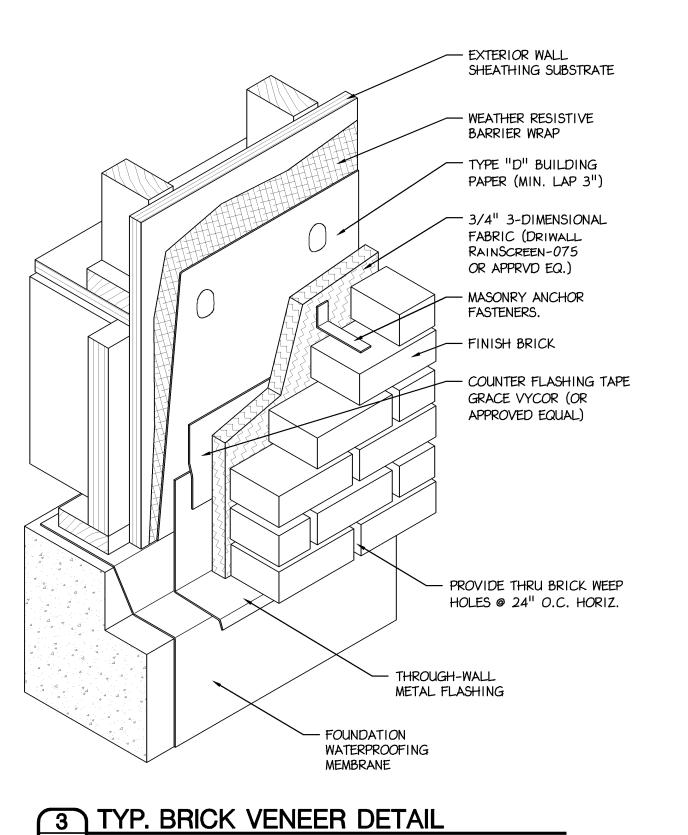

A-9 | Scale: 3/4" = 1-0"

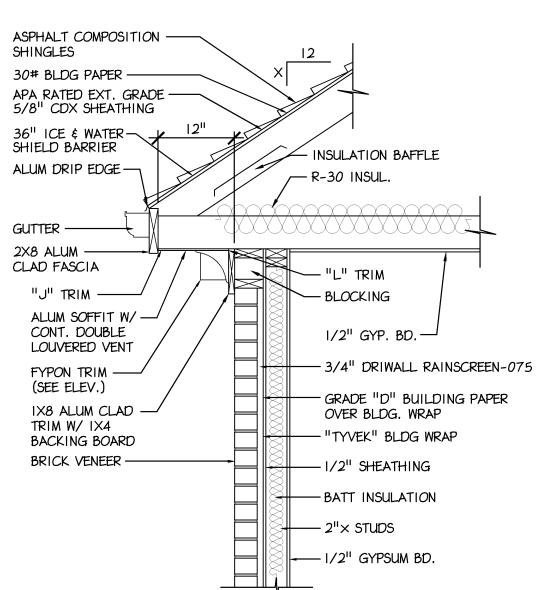

4 TYP. EXTERIOR WALL DETAIL

A-9 Scale: 3/4" = 1-0"

3 08-27-08 EMH ISSUED FOR PERMITTING 4 | 10-08-08 | EMH CLIENT / GC REVISIONS 5 10-20-08 EMH CURRENT DATE APPROVED BY Robin J. Kohn, AIA October 20, 2008 Shumaker Residence 183 DAVIS BRIDGE ROAD BERNVILLE, PA 19506 PENN TOWNSHIP **BERKS COUNTY** SHEET TITLE **DETAILS** SHEET NUMBER

A-9

REV 5

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B2915

NO. DATE BY ISSUE

1 08-12-08 EMH

2 08-18-08 EMH

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> Contact Person: Edward (Kipp) Happ (610) 917-8831

> > DRAWN BY

ISSUED FOR REVIEW


REVISED SKETCH PLANS


SSUED FOR FINAL SKETCH REVIEW

CHK'D BY

Regis W. Kubit, PE

fax (610) 917-8836

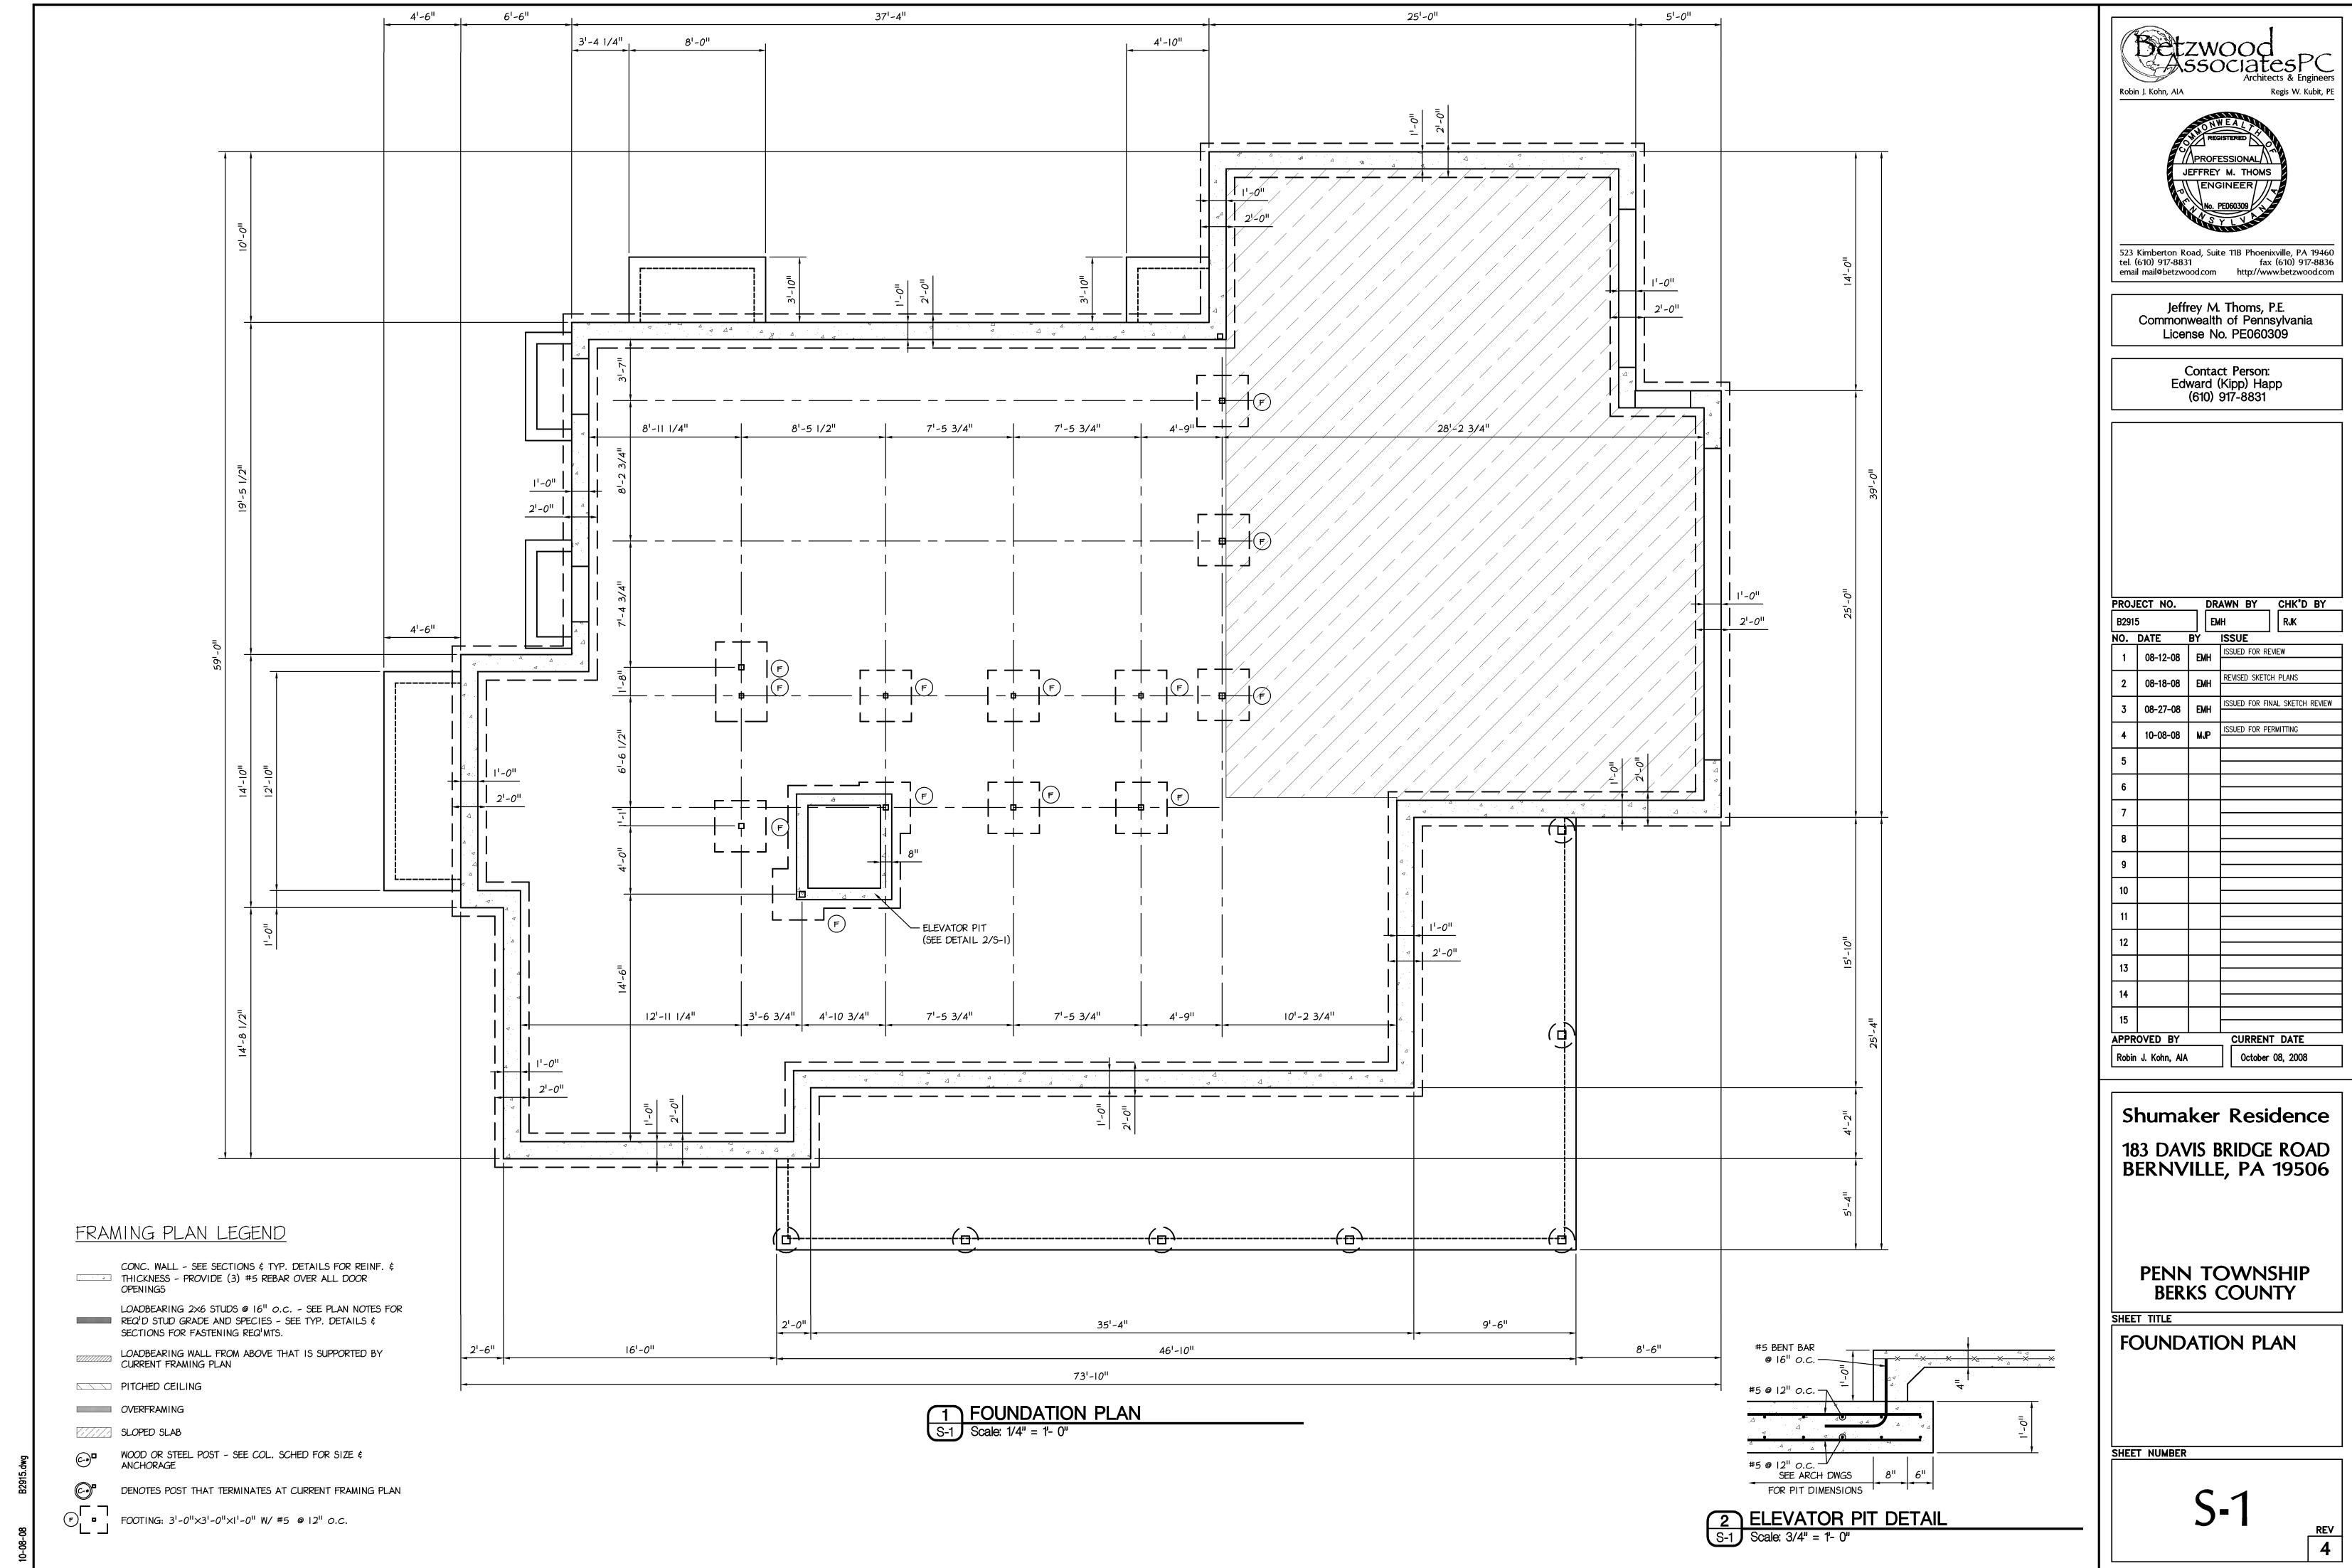

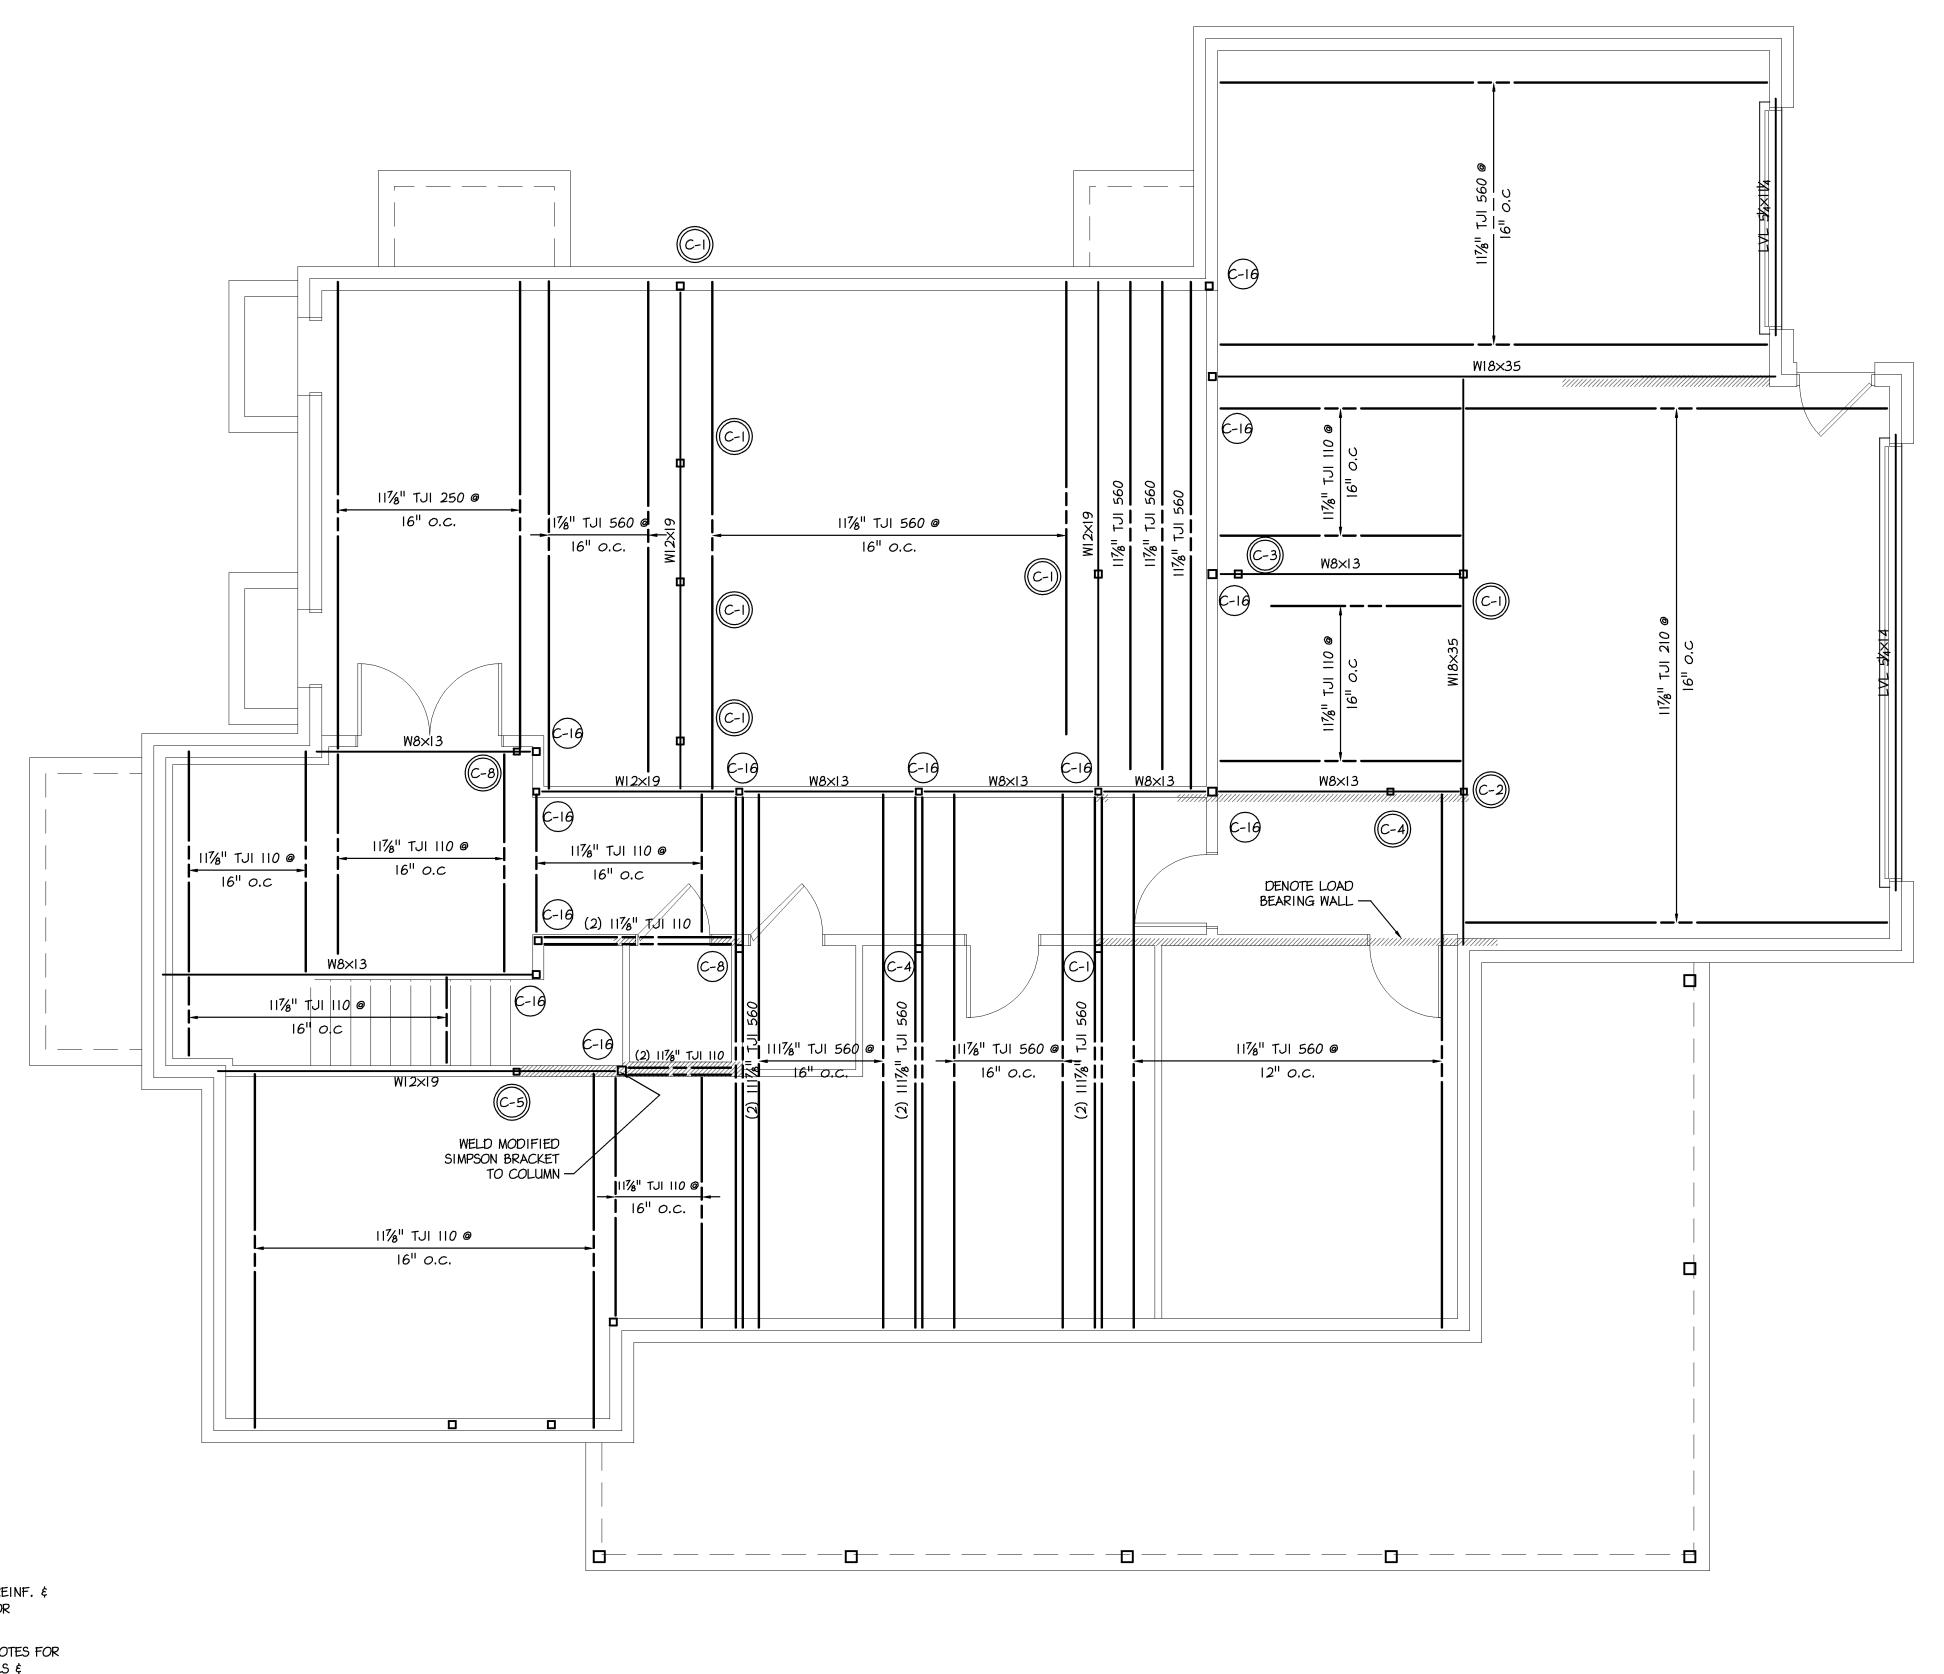

1 FIRST FLOOR FRAMING PLAN
S-2 Scale: 1/4" = 1'- 0"

CHK'D BY DRAWN BY NO. DATE BY ISSUE ISSUED FOR REVIEW 1 | 08-12-08 | EMH REVISED SKETCH PLANS 2 | 08-18-08 | EMH SSUED FOR FINAL SKETCH REVIEW 3 08-27-08 EMH 4 | 10-08-08 | MJP CURRENT DATE APPROVED BY Robin J. Kohn, AIA October 08, 2008

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Shumaker Residence 183 DAVIS BRIDGE ROAD BERNVILLE, PA 19506

PENN TOWNSHIP **BERKS COUNTY** 

SHEET TITLE

FIRST FLOOR FRAMING PLAN

SHEET NUMBER

DENOTES POST THAT TERMINATES AT CURRENT FRAMING PLAN

FRAMING PLAN LEGEND

CONC. WALL - SEE SECTIONS & TYP. DETAILS FOR REINF. & THICKNESS - PROVIDE (3) #5 REBAR OVER ALL DOOR

LOADBEARING 2x6 STUDS @ 16" O.C. - SEE PLAN NOTES FOR REQ'D STUD GRADE AND SPECIES - SEE TYP. DETAILS \$ SECTIONS FOR FASTENING REQ'MTS.


LOADBEARING WALL FROM ABOVE THAT IS SUPPORTED BY CURRENT FRAMING PLAN

PITCHED CEILING

OVERFRAMING

SLOPED SLAB WOOD OR STEEL POST - SEE COL. SCHED FOR SIZE \$

FOOTING: 3'-0"×3'-0"×1'-0" W/ #5 @ 12" O.C.

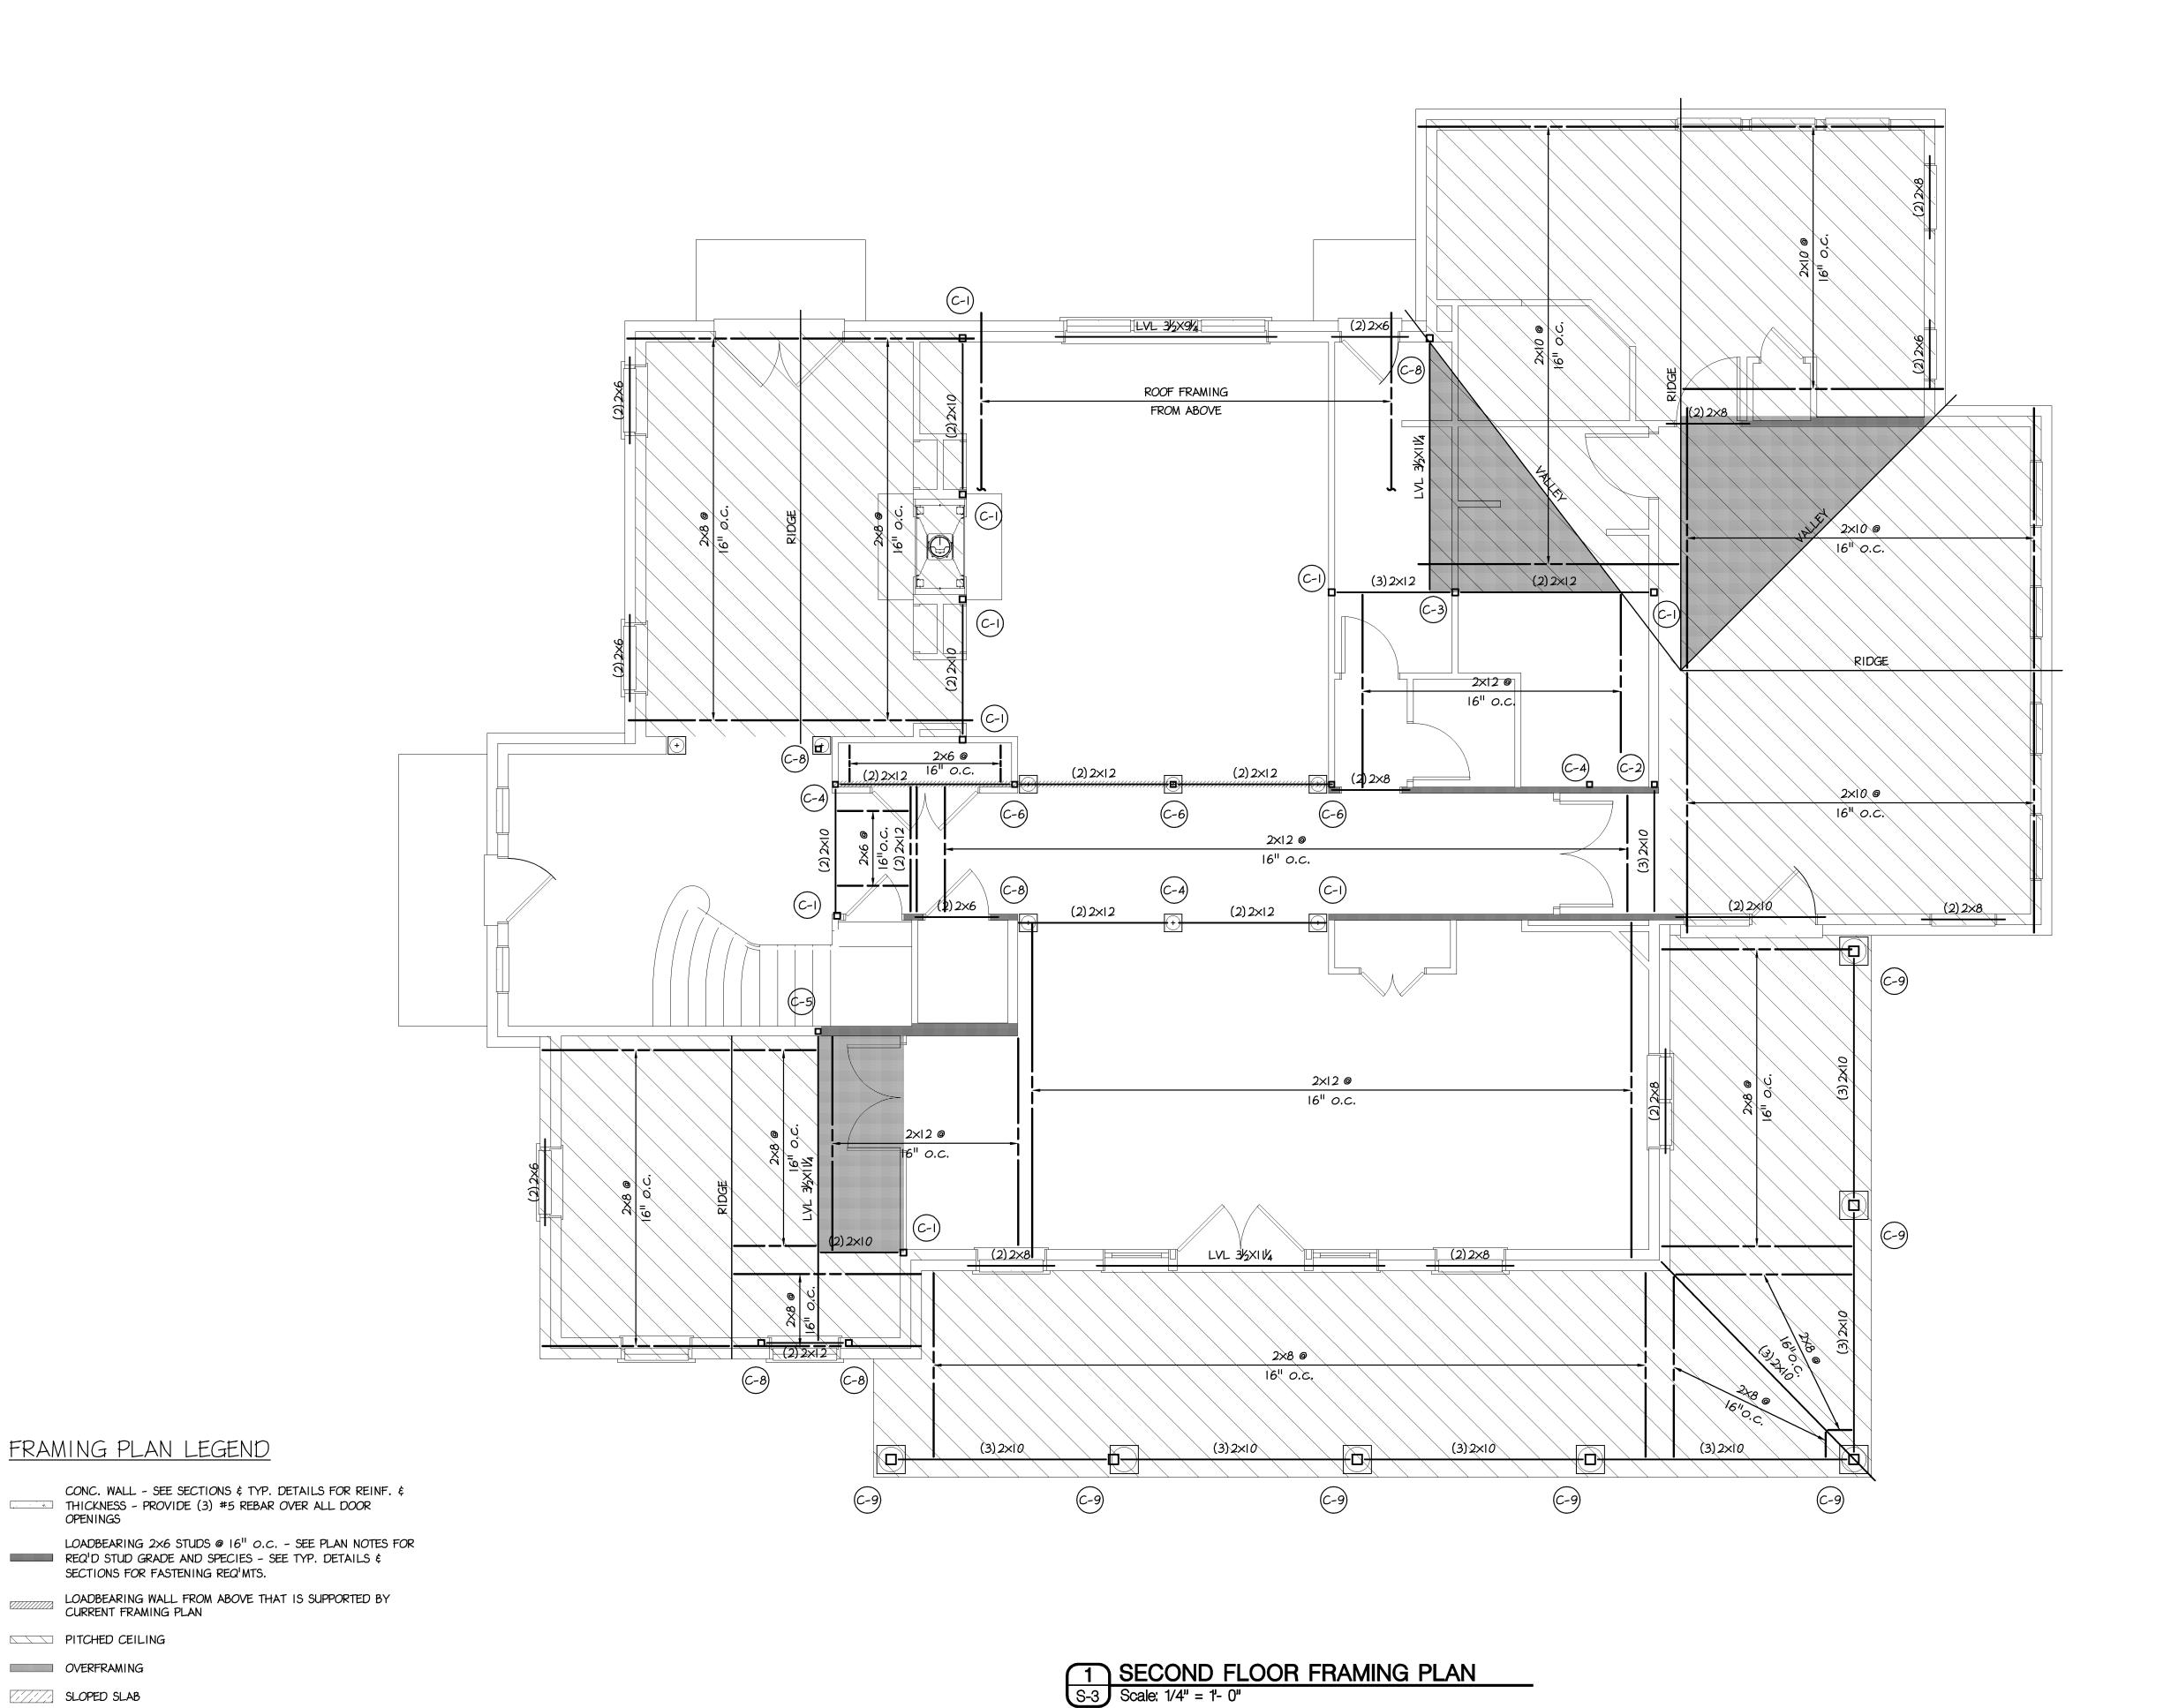

Detzwood AssociatesPC Robin J. Kohn, AIA JEFFREY M. THOMS 523 Kimberton Road, Suite 11B Phoenixville, PA 19460 fax (610) 917-8836 tel. (610) 917-8831 ´ email mail@betzwood.com http://www.betzwood.com Jeffrey M. Thoms, P.E. Commonwealth of Pennsylvania License No. PE060309 Contact Person: Edward (Kipp) Happ (610) 917-8831 DRAWN BY NO. DATE BY ISSUE ISSUED FOR REVIEW 08-12-08 EMH REVISED SKETCH PLANS 2 | 08-18-08 | EMH 4 | 10-08-08 | MJP

Regis W. Kubit, PE

CHK'D BY

SSUED FOR FINAL SKETCH REVIEW APPROVED BY CURRENT DATE October 08, 2008 Robin J. Kohn, AIA

Shumaker Residence 183 DAVIS BRIDGE ROAD BERNVILLE, PA 19506

> PENN TOWNSHIP BERKS COUNTY

SHEET TITLE

SECOND FLOOR FRAMING PLAN

SHEET NUMBER

FOOTING: 3'-0"×3'-0"×1'-0" W/ #5 @ 12" O.C.


WOOD OR STEEL POST - SEE COL. SCHED FOR SIZE \$

DENOTES POST THAT TERMINATES AT CURRENT FRAMING PLAN

PITCHED CEILING

OVERFRAMING

SLOPED SLAB

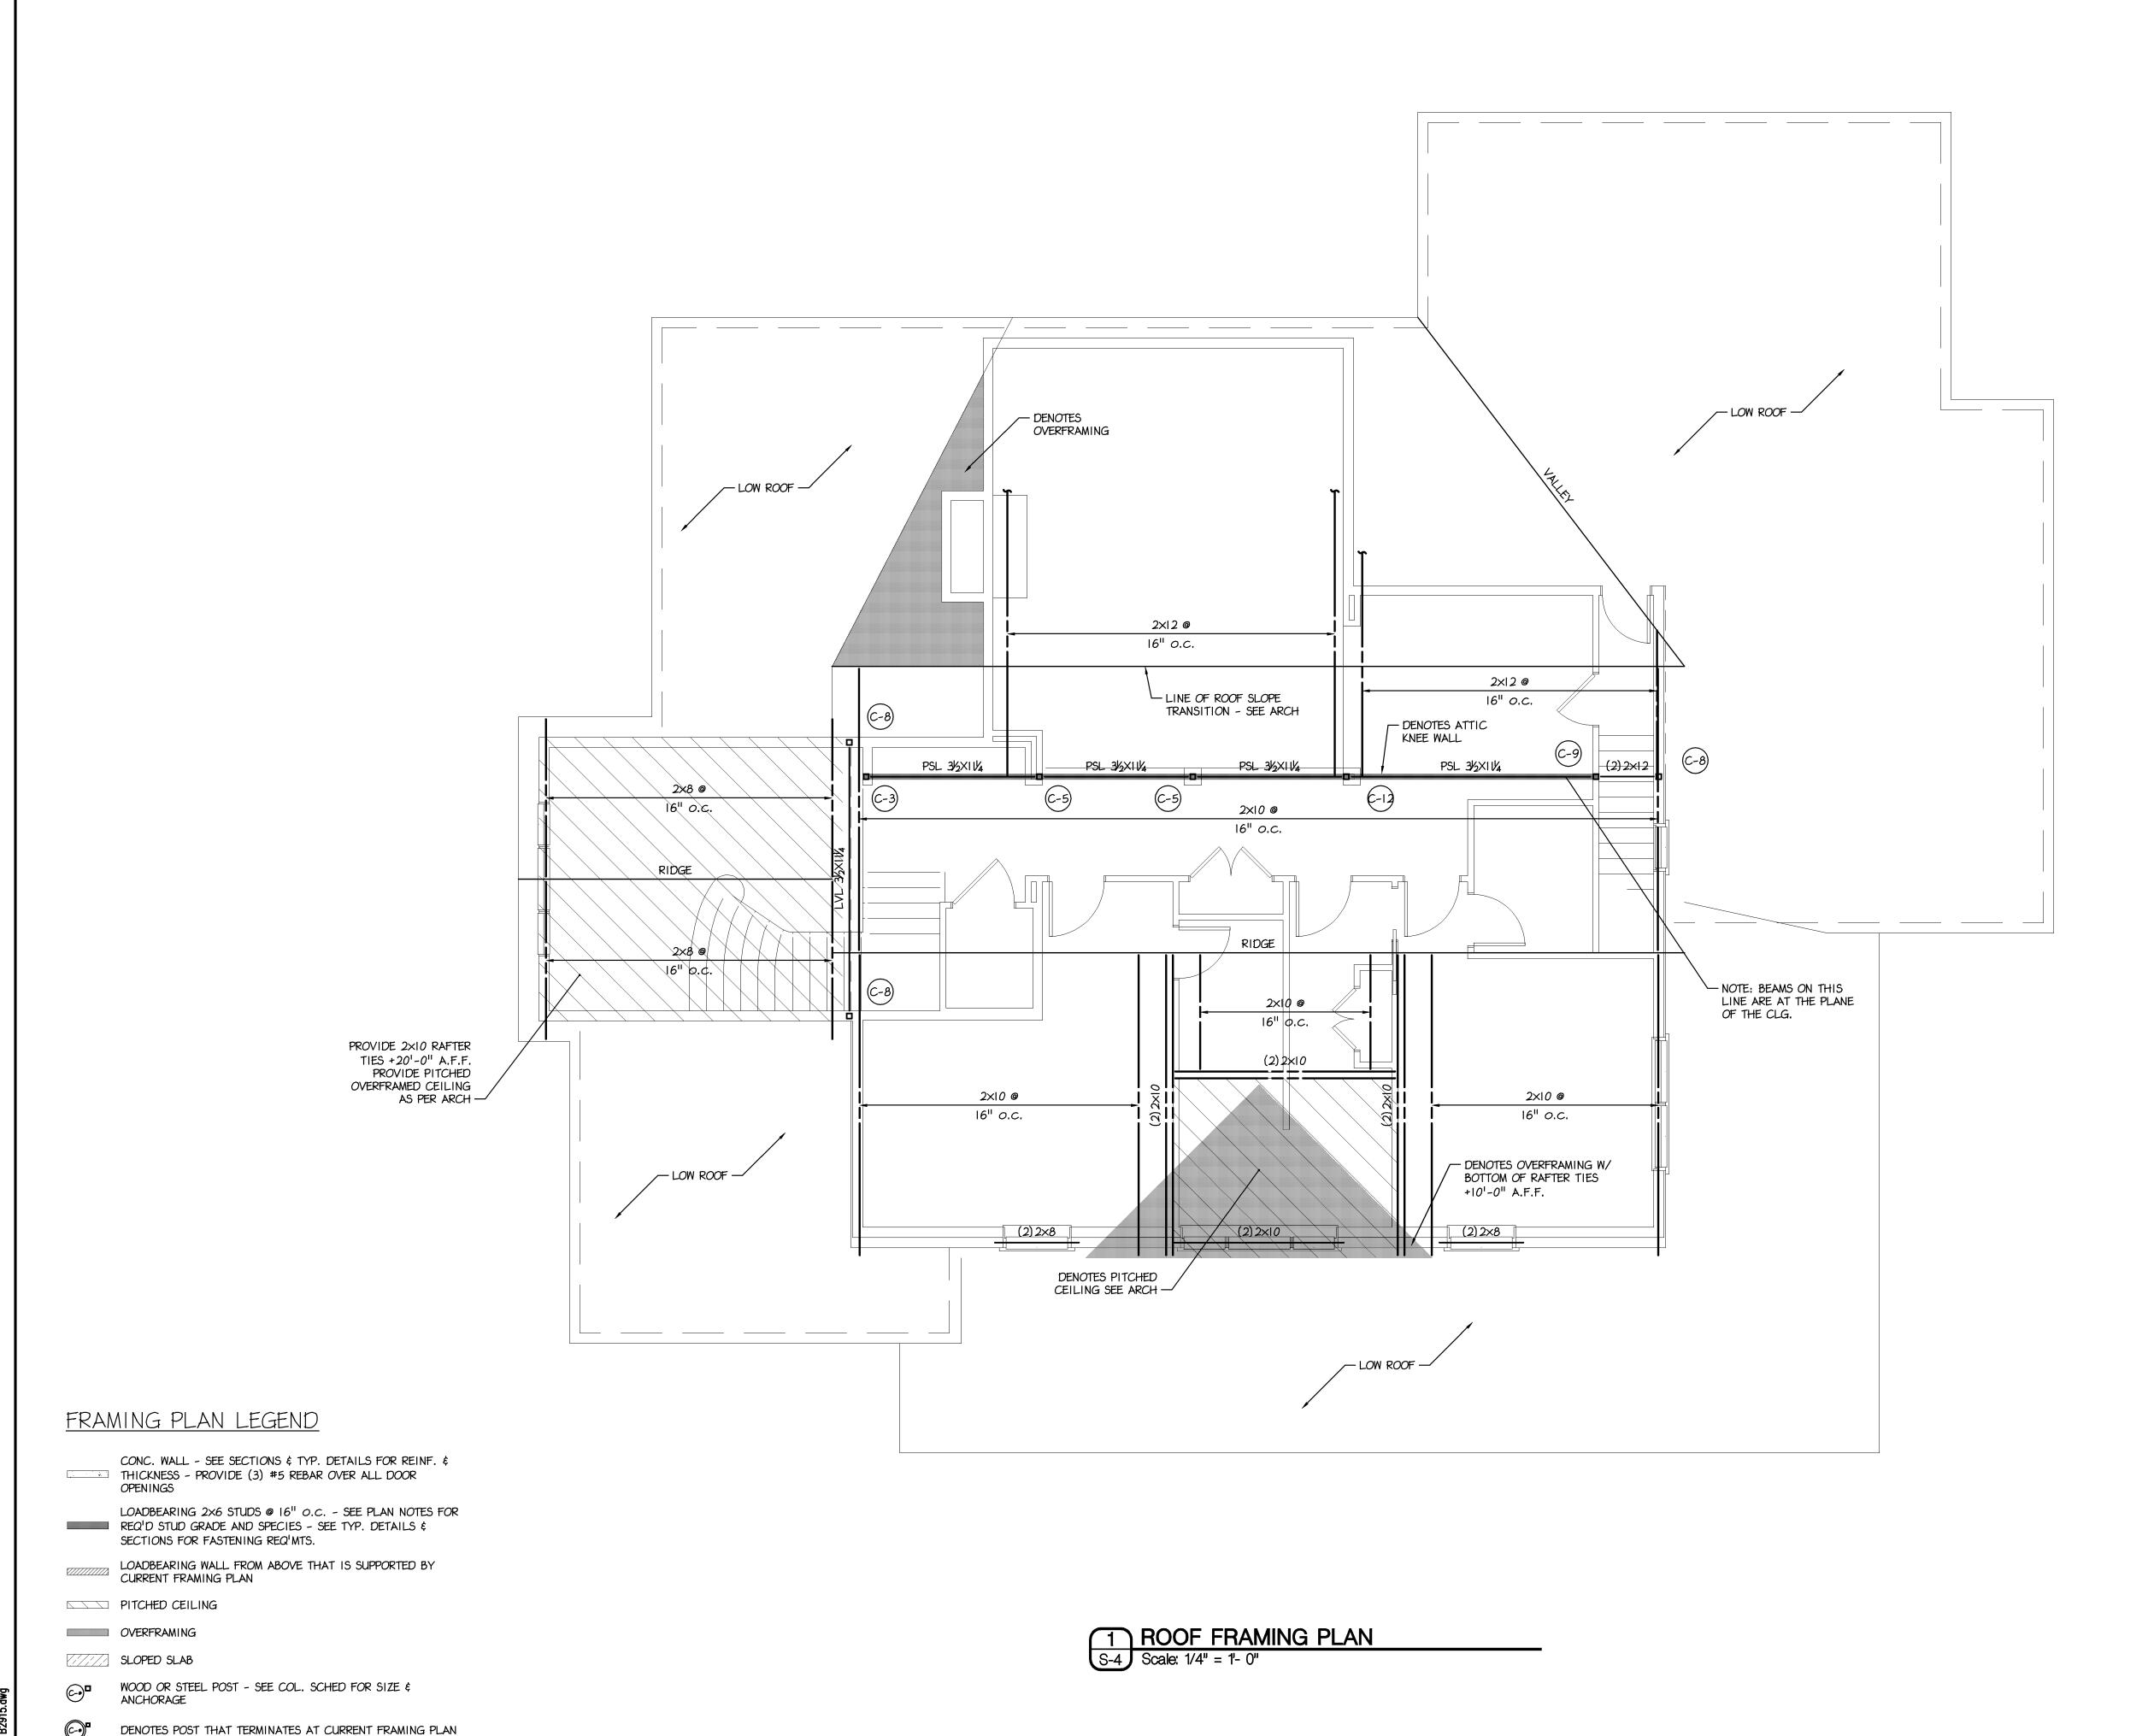

Robin J. Kohn, AIA Regis W. Kubit, PE JEFFREY M. THOMS 523 Kimberton Road, Suite 11B Phoenixville, PA 19460 tel. (610) 917-8831 É fax (610) 917-8836 email mail@betzwood.com http://www.betzwood.com Jeffrey M. Thoms, P.E. Commonwealth of Pennsylvania License No. PE060309 Contact Person: Edward (Kipp) Happ (610) 917-8831 DRAWN BY CHK'D BY NO. DATE BY ISSUE ISSUED FOR REVIEW 1 | 08-12-08 | EMH 2 08-18-08 EMH 3 08-27-08 EMH 4 10-08-08 MJP

REVISED SKETCH PLANS SSUED FOR FINAL SKETCH REVIEW APPROVED BY CURRENT DATE Robin J. Kohn, AIA October 08, 2008

Shumaker Residence 183 DAVIS BRIDGE ROAD BERNVILLE, PA 19506


PENN TOWNSHIP **BERKS COUNTY** 


SHEET TITLE

ROOF FRAMING PLAN

SHEET NUMBER

FOOTING: 3'-0"×3'-0"×1'-0" W/ #5 @ 12" O.C.

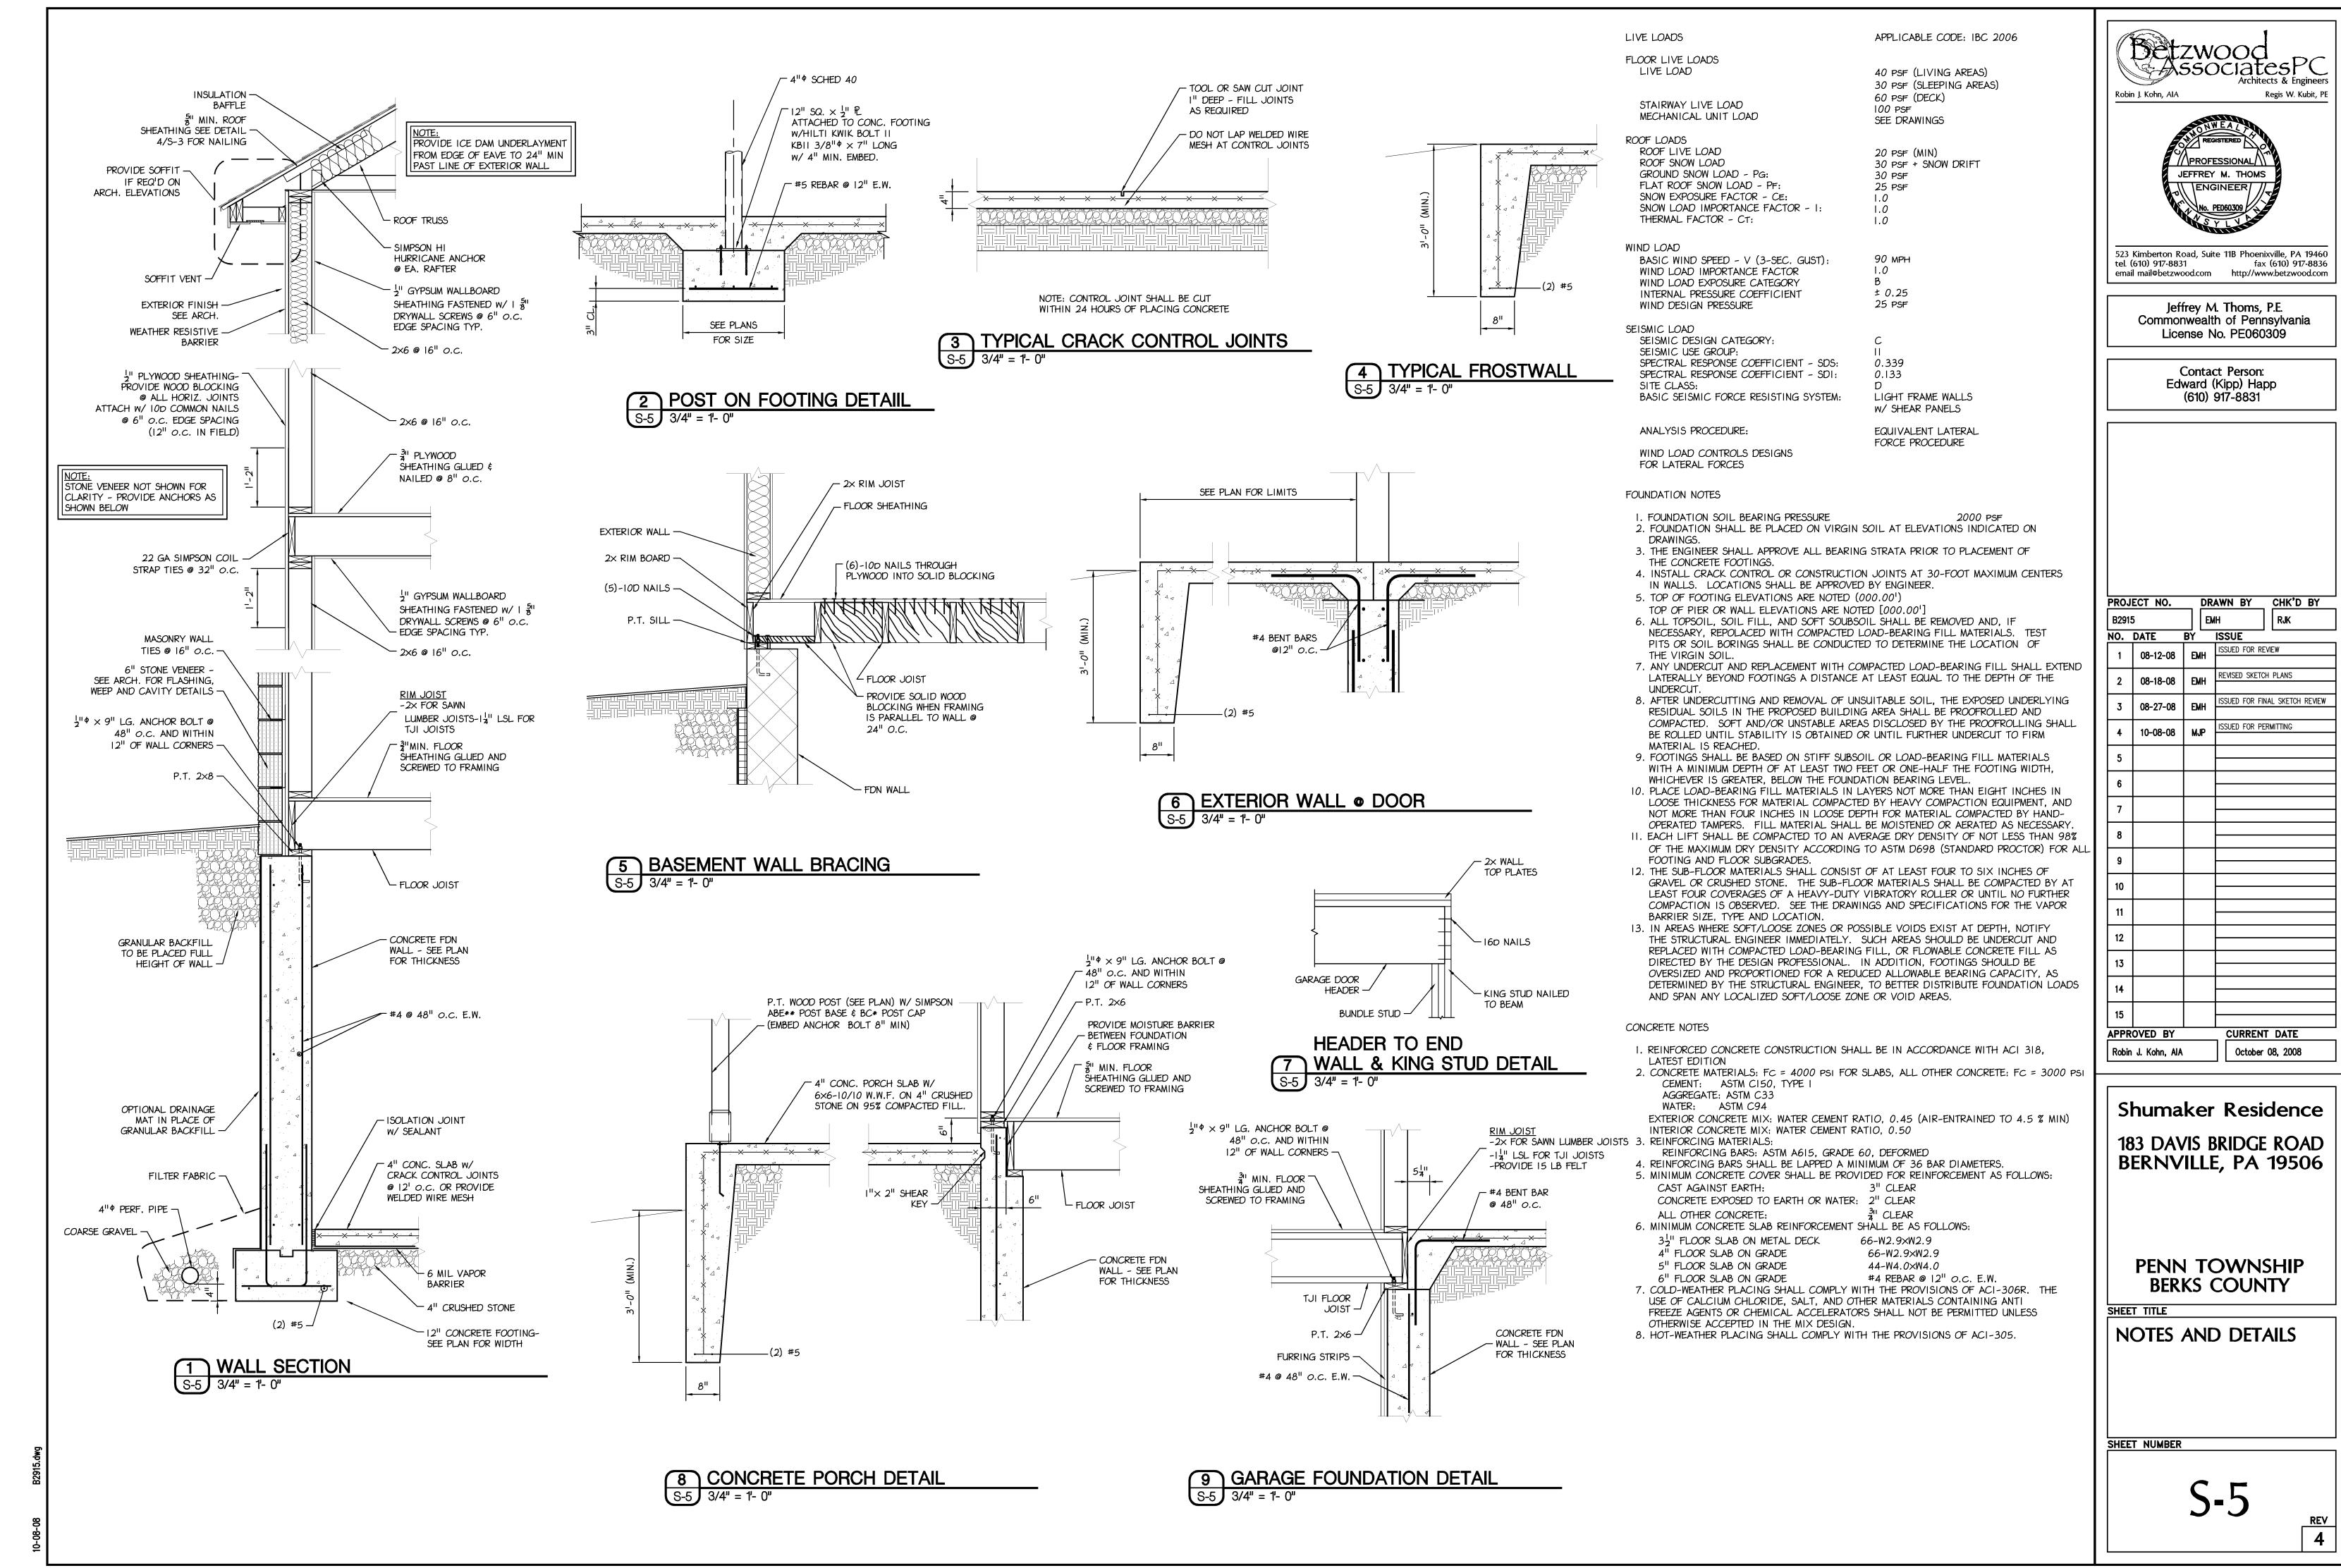

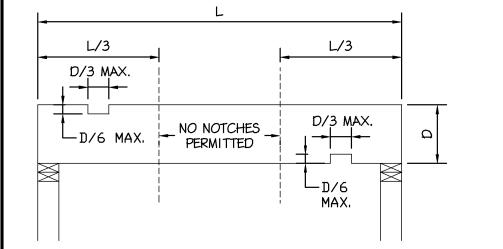

**ALLOWABLE NOTCHING** 

**OUTSIDE CORNER DETAIL** 

- GYPSUM WALL

-100 NAIL @ 12" O.C.

NOT AT PANEL EDGES

ON ALL FRAMING MEMBERS

**4** EXTERIOR CORNER FRAMING DETAIL

BOARD

IN SAWN LUMBER

¼" PLYWOOD

100 NAIL @ 6" O.C.

(ALL PANEL EDGES)

SHEATHING -

D/6 MAX.— FLOOR JOIST - END CUTS

ALLOWABLE END CUTS 1 IN SAWN LUMBER

- GYPSUM WALL

INSIDE CORNER DETAIL

-¼" PLYWOOD

SHEATHING

-100 NAIL @ 6" O.C. ON

ALL FRAMING MEMBERS AT

ON ALL FRAMING MEMBERS

NOT AT PANEL EDGES


F HOLE IS BETWEEN 40 PERCENT AND

60 PERCENT OF STUD DEPTH. THEN STUD


MUST BE DOUBLE AND NO MORE THAN TWO

SUCCESSIVE STUDS ARE DOUBLED AND SO

PANEL EDGES AND 12" O.C.

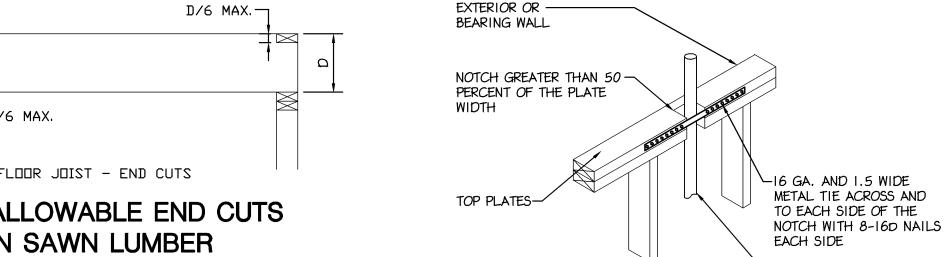

TOP PLATE FRAMING TO **ACCOMMODATE PIPING** 

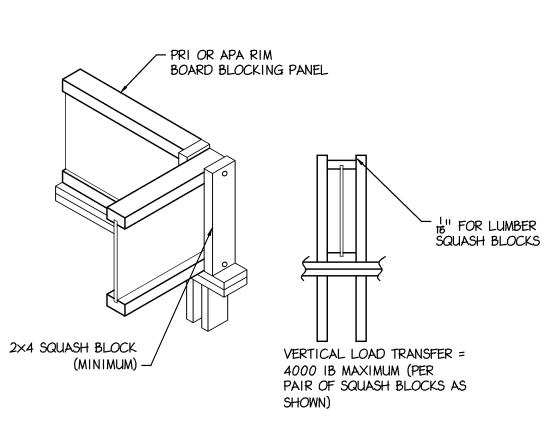

5 SQUASH BLOCK DETAIL

MARK	SIZE	BASE CONN.	CAP CONN.
C-1	(2) 2×4	(4) 160 IN BOTTOM PL	(4) 160 IN TOP PL
C-2	(3) 2×4	(6) 160 IN BOTTOM PL	(6) 160 IN TOP PL
C-3	LSL 3½" × 3½"	(4) 160 IN BOTTOM PL	(4) 160 IN TOP PL
C-4	LSL 3½" × 483"	(6) 160 IN BOTTOM PL	(6) 160 IN TOP PL
C-5	LSL 3½" × 5½"	(8) 160 IN BOTTOM PL	(8) 160 IN TOP PL
C-6	LSL $3\frac{1}{2}$ " $\times 7\frac{1}{4}$ "	(10) 160 IN BOTTOM PL	(10) 160 IN TOP PL
C-7	LSL 3½" × 85"	(12) 160 IN BOTTOM PL	(12) 160 IN TOP PL
C-8	(2) 2×6	(6) 160 IN BOTTOM PL	(6) 160 IN TOP PL
C-9	(3) 2×6	(9) 160 IN BOTTOM PL	(9) 160 IN TOP PL
C-10	(4) 2×6	(12) 160 IN BOTTOM PL	(12) 160 IN TOP PL
C-11	$PSL \ 3_{2}^{1}" \times 3_{2}^{1}"$	PREFAB CONN. BY OTHERS	PREFAB CONN. BY OTHERS
C-12	PSL 32" × 54"	SIMPSON STANDARD CONN.	SIMPSON STANDARD CONN.
C-13	PSL 3½" × 7"	SIMPSON STANDARD CONN.	SIMPSON STANDARD CONN.
C-14	PSL 51 × 51	SIMPSON STANDARD CONN.	SIMPSON STANDARD CONN.
C-15	PSL 5½" × 7"	SIMPSON STANDARD CONN.	SIMPSON STANDARD CONN.
C-16	4" \$ SCHED 40	SEE DETAIL	N/A

**COLUMN SCHEDULE** 

### STRUCTURAL STEEL NOTES

1. STRUCTURAL STEEL CONSTRUCTION SHALL BE IN ACCORDANCE WITH AISC'S 'CODE OF STANDARD PRACTICE FOR STEEL BUILDINGS AND BRIDGES' AND 'SPECIFICATION FOR STRUCTURAL STEEL BUILDINGS - ALLOWABLE STRESS DESIGN', LATEST

EDITION 2. STEEL MATERIALS W-SHAPES:

ASTM A 992, FY=50,000 PSI ASTM A 36, FY=36,000 PSI ASTM A 36, FY=36,000 PSI COLD-FORMED HOLLOW ASTM A 500, GRADE B STRUCTURAL SECTIONS ASTM A 501,

STEEL PIPE 3. CONNECTOR MATERIALS: BOLTS

CHANNELS, ANGLES

HOT-FORMED HOLLOW

PLATE AND BAR

FY=46,000 PSI FY=46,000 PSI STRUCTURAL SECTIONS ASTM A 53, TYPE E OR S GRADE B, FY=36,000 PSI

ASTM F1852, TYPE I, TENSION CONTROL HIGH STRENGTH BOLT-NUT-WASHER ASSEMBLY WITH HEX OR ROUND HEADS AND SPLINED ENDS. COMPLY WITH AWS REQUIREMENT

UNHEADED ANCHOR RODS ASTM F1554, GRADE 36, FY=36,000 PSI 4. BEAM-TO-BEAM AND BEAM-TO-COLUMN CONNECTIONS SHALL BE AISC STANDARD FULL DEPTH CONNECTIONS, UNLESS NOTED OTHERWISE. WHERE REACTIONS ARE INDICATED ON THE DRAWINGS, THE CONNECTION SHALL BE PROVIDED BY THE FABRICATOR. DETAILS AND CALCULATIONS, PREPARED BY A LICENSED ENGINEER SHALL BE PART OF THE SHOP DRAWING SUBMISSION.

5. ALL CONNECTIONS SHALL BE HIGH-STRENGTH FRICTION BOLTS OR WELDS OF EQUAL STRENGTH. ANCHOR BOLTS AND FIELD CONNECTIONS OF GIRTS FOR SHEAR SHALL BE UNFINISHED BOLTS.

6. ELEVATION OF TOP OF STEEL MEMBERS ARE NOTED (+ -). 7. STEEL JOISTS SHALL BE FABRICATED AND ERECTED IN ACCORDANCE WITH LATEST

AISC AND SJI SPECIFICATIONS. 8. JOIST BRIDGING SHALL BE DESIGNED AND INSTALLED ACCORDING TO THE LATEST SJI SPECIFICATIONS. BRIDGING SHALL NOT BE MODIFIED WITHOUT THE APPROVAL OF THE STRUCTURAL ENGINEER.

9. METAL DECKING SHALL BE INSTALLED IN 3 SPAN CONDITIONS MINIMUM.

### TIMBER NOTES

2. ALL SAWN LUMBER SHALL BE HEM-FIR #2, 19% MAXIMUM MOISTURE CONTENT OR BETTER. THE MINIMUM DESIGN VALUES SHALL BE:

FB = 850 PSI FV = 150 PSI

MINIMUM DESIGN VALUES FOR PARALLAM (PSL) MEMBERS SHALL BE:

FB = 2900 PSI

FC = 2900 PSI

E = 2,000,000 PSI

MINIMUM DESIGN VALUES FOR MICROLLAM (LVL) MEMBERS SHALL BE:

FV = 285 PSI

3. ALL STEEL TIMBER FASTENINGS AND JOIST HANGERS SHALL BE A MINIMUM OF 16

4. ALL WOOD PLATES BEARING ON MASONRY OR CONCRETE WALLS SHALL BE PRESSURE TREATED LUMBER UNLESS NOTED OTHERWISE.

ALL DOUBLE TJI JOISTS SHALL BE ATTACHED AS PER MANUFACTURERS

RECOMMENDATIONS.

7. ALL PLYWOOD ROOF SHEATHING SHALL BE SECURED WITH PLY CLIPS AT CENTERLINE

9. PLYWOOD SHALL BE SECURED USING 8D NAILS. 10. ALL PLYWOOD SHALL MEET THE REQUIREMENTS OF THE PLYWOOD DESIGN

11. WOOD TRUSS JOISTS ARE TO BE DESIGNED BY THE MANUFACTURER, ALL CALCULATIONS SHALL BE SEALED BY A REGISTERED ENGINEER AND SHALL BE

I. ALL WOOD FRAMING SHALL BE FABRICATED, ERECTED, AND BRACED IN ACCORDANCE WITH THE NATIONAL DESIGN SPECIFICATION FOR WOOD CONSTRUCTION, LATEST

FC = 1300 PSI

E = 1,300,000 PSI

FV = 290 PSI

FB = 2600 PSI

FC = 2510 PSI E = 1,900,000 PSI

GA. GALVANIZED STEEL WITH A RATED LOAD CAPACITY EQUAL TO OR EXCEEDING THE IMPOSED LOADING REQUIREMENTS


5. ALL DOUBLE JOISTS SHALL BE SPIKED TOGETHER WITH 10D NAILS @ 16" O.C.


6. ALL WOOD BEAMS MADE UP OF 3 OR MORE MEMBERS SHALL BE BOLTED TOGETHER WITH 5" \$ BOLTS @ 32" O.C.

OF PLYWOOD SPAN AND AT ALL EDGES PARALLEL TO SPAN. 8. PLYWOOD SHEATHING SHALL BE CONTINUOUS OVER A MINIMUM OF 3 SPANS.


SPECIFICATIONS AS PUBLISHED BY THE AMERICAN PLYWOOD ASSOCIATION AND THE REQUIREMENTS OF THE AMERICAN INSTITUTE OF TIMBER CONSTRUCTION, LATEST

SUBMITTED FOR APPROVAL BY THE STRUCTURAL ENGINEER.

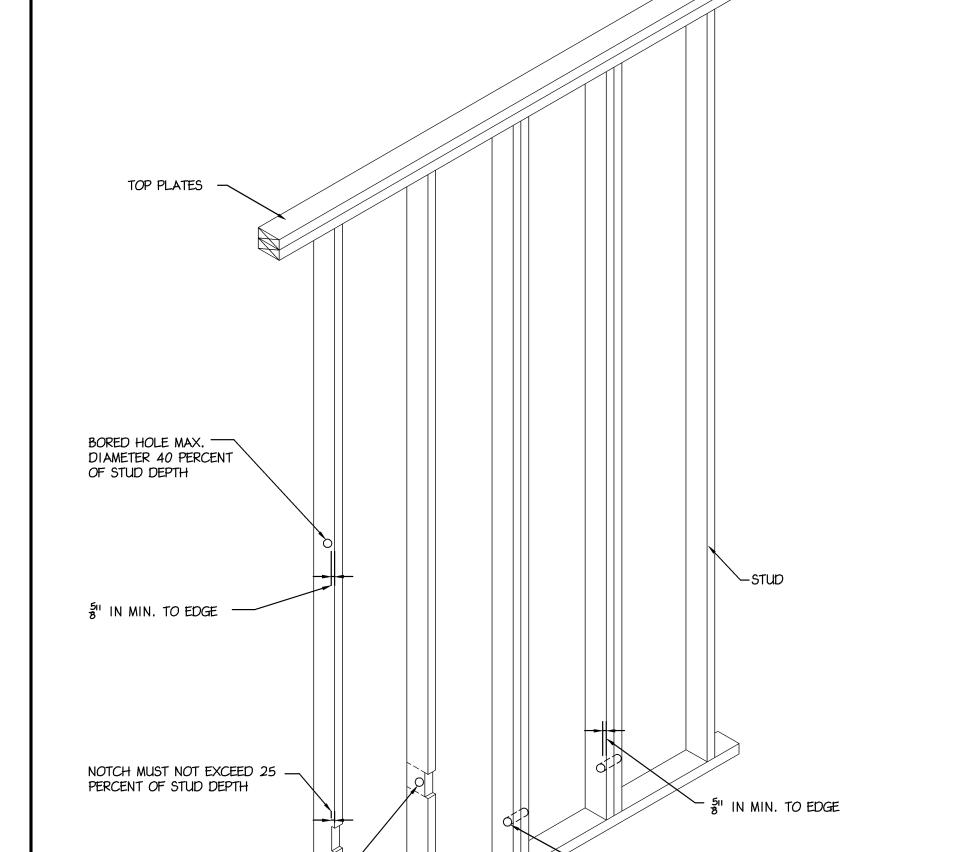


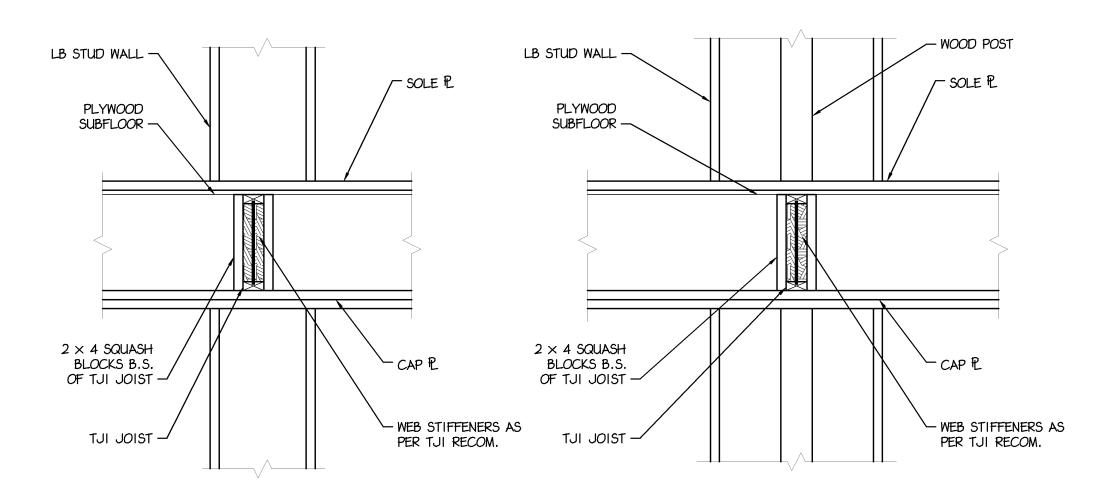

# 8 TJI © LOAD BEARING COND. DETAIL S-6 3/4" = 1-0"

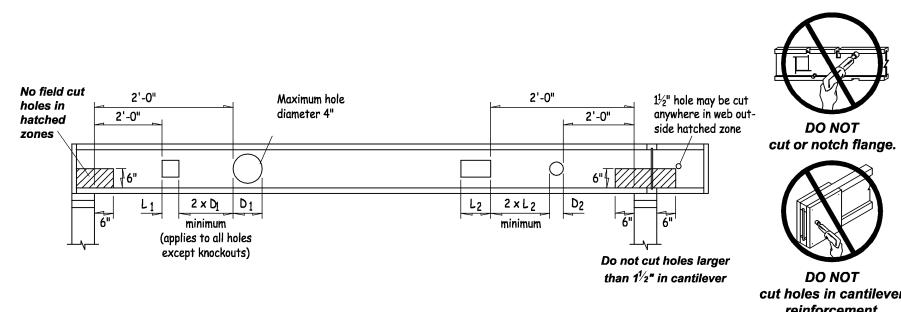

**ALLOWABLE HOLES - TJI® Joists** 

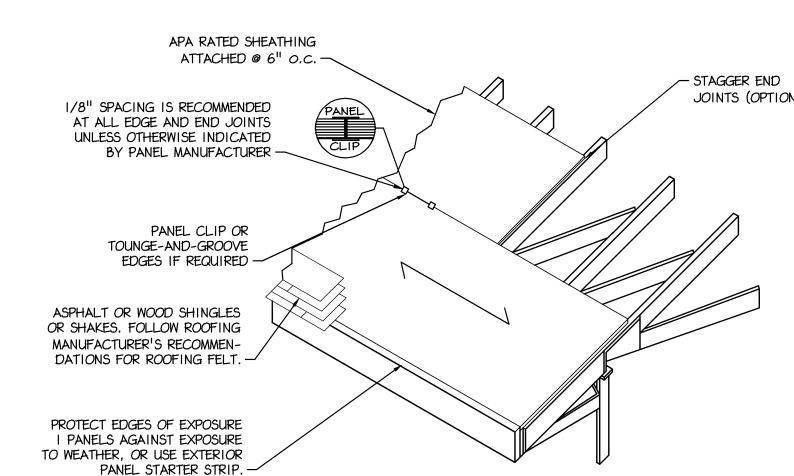

9 PANEL ROOF SHEATHING DETAIL

JOINTS (OPTIONAL)

**NOTES AND DETAILS** 

Betzwood

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### Sociates PC

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DRAWN BY

SSUED FOR REVIEW

REVISED SKETCH PLANS

ISSUED FOR PERMITTING

CURRENT DATE

Shumaker Residence

183 DAVIS BRIDGE ROAD

BERNVILLE, PA 19506

PENN TOWNSHIP

**BERKS COUNTY** 

October 08, 2008

SSUED FOR FINAL SKETCH REVIEW

BY ISSUE

08-12-08

3 | 08-27-08 | EMH

4 | 10-08-08 | MJP

2 | 08-18-08 |

APPROVED BY

Regis W. Kubit, Pl

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CHK'D BY

RJK


http://www.betzwood.com


SHEET NUMBER

NOTCHING AND BORED HOLE LIMITATIONS FOR (7) EXTERIOR WALLS AND BEARING WALLS


BORED HOLES SHALL NOT BE -LOCATED IN THE SAME CROSS


SECTION OF CUT OR NOTCH

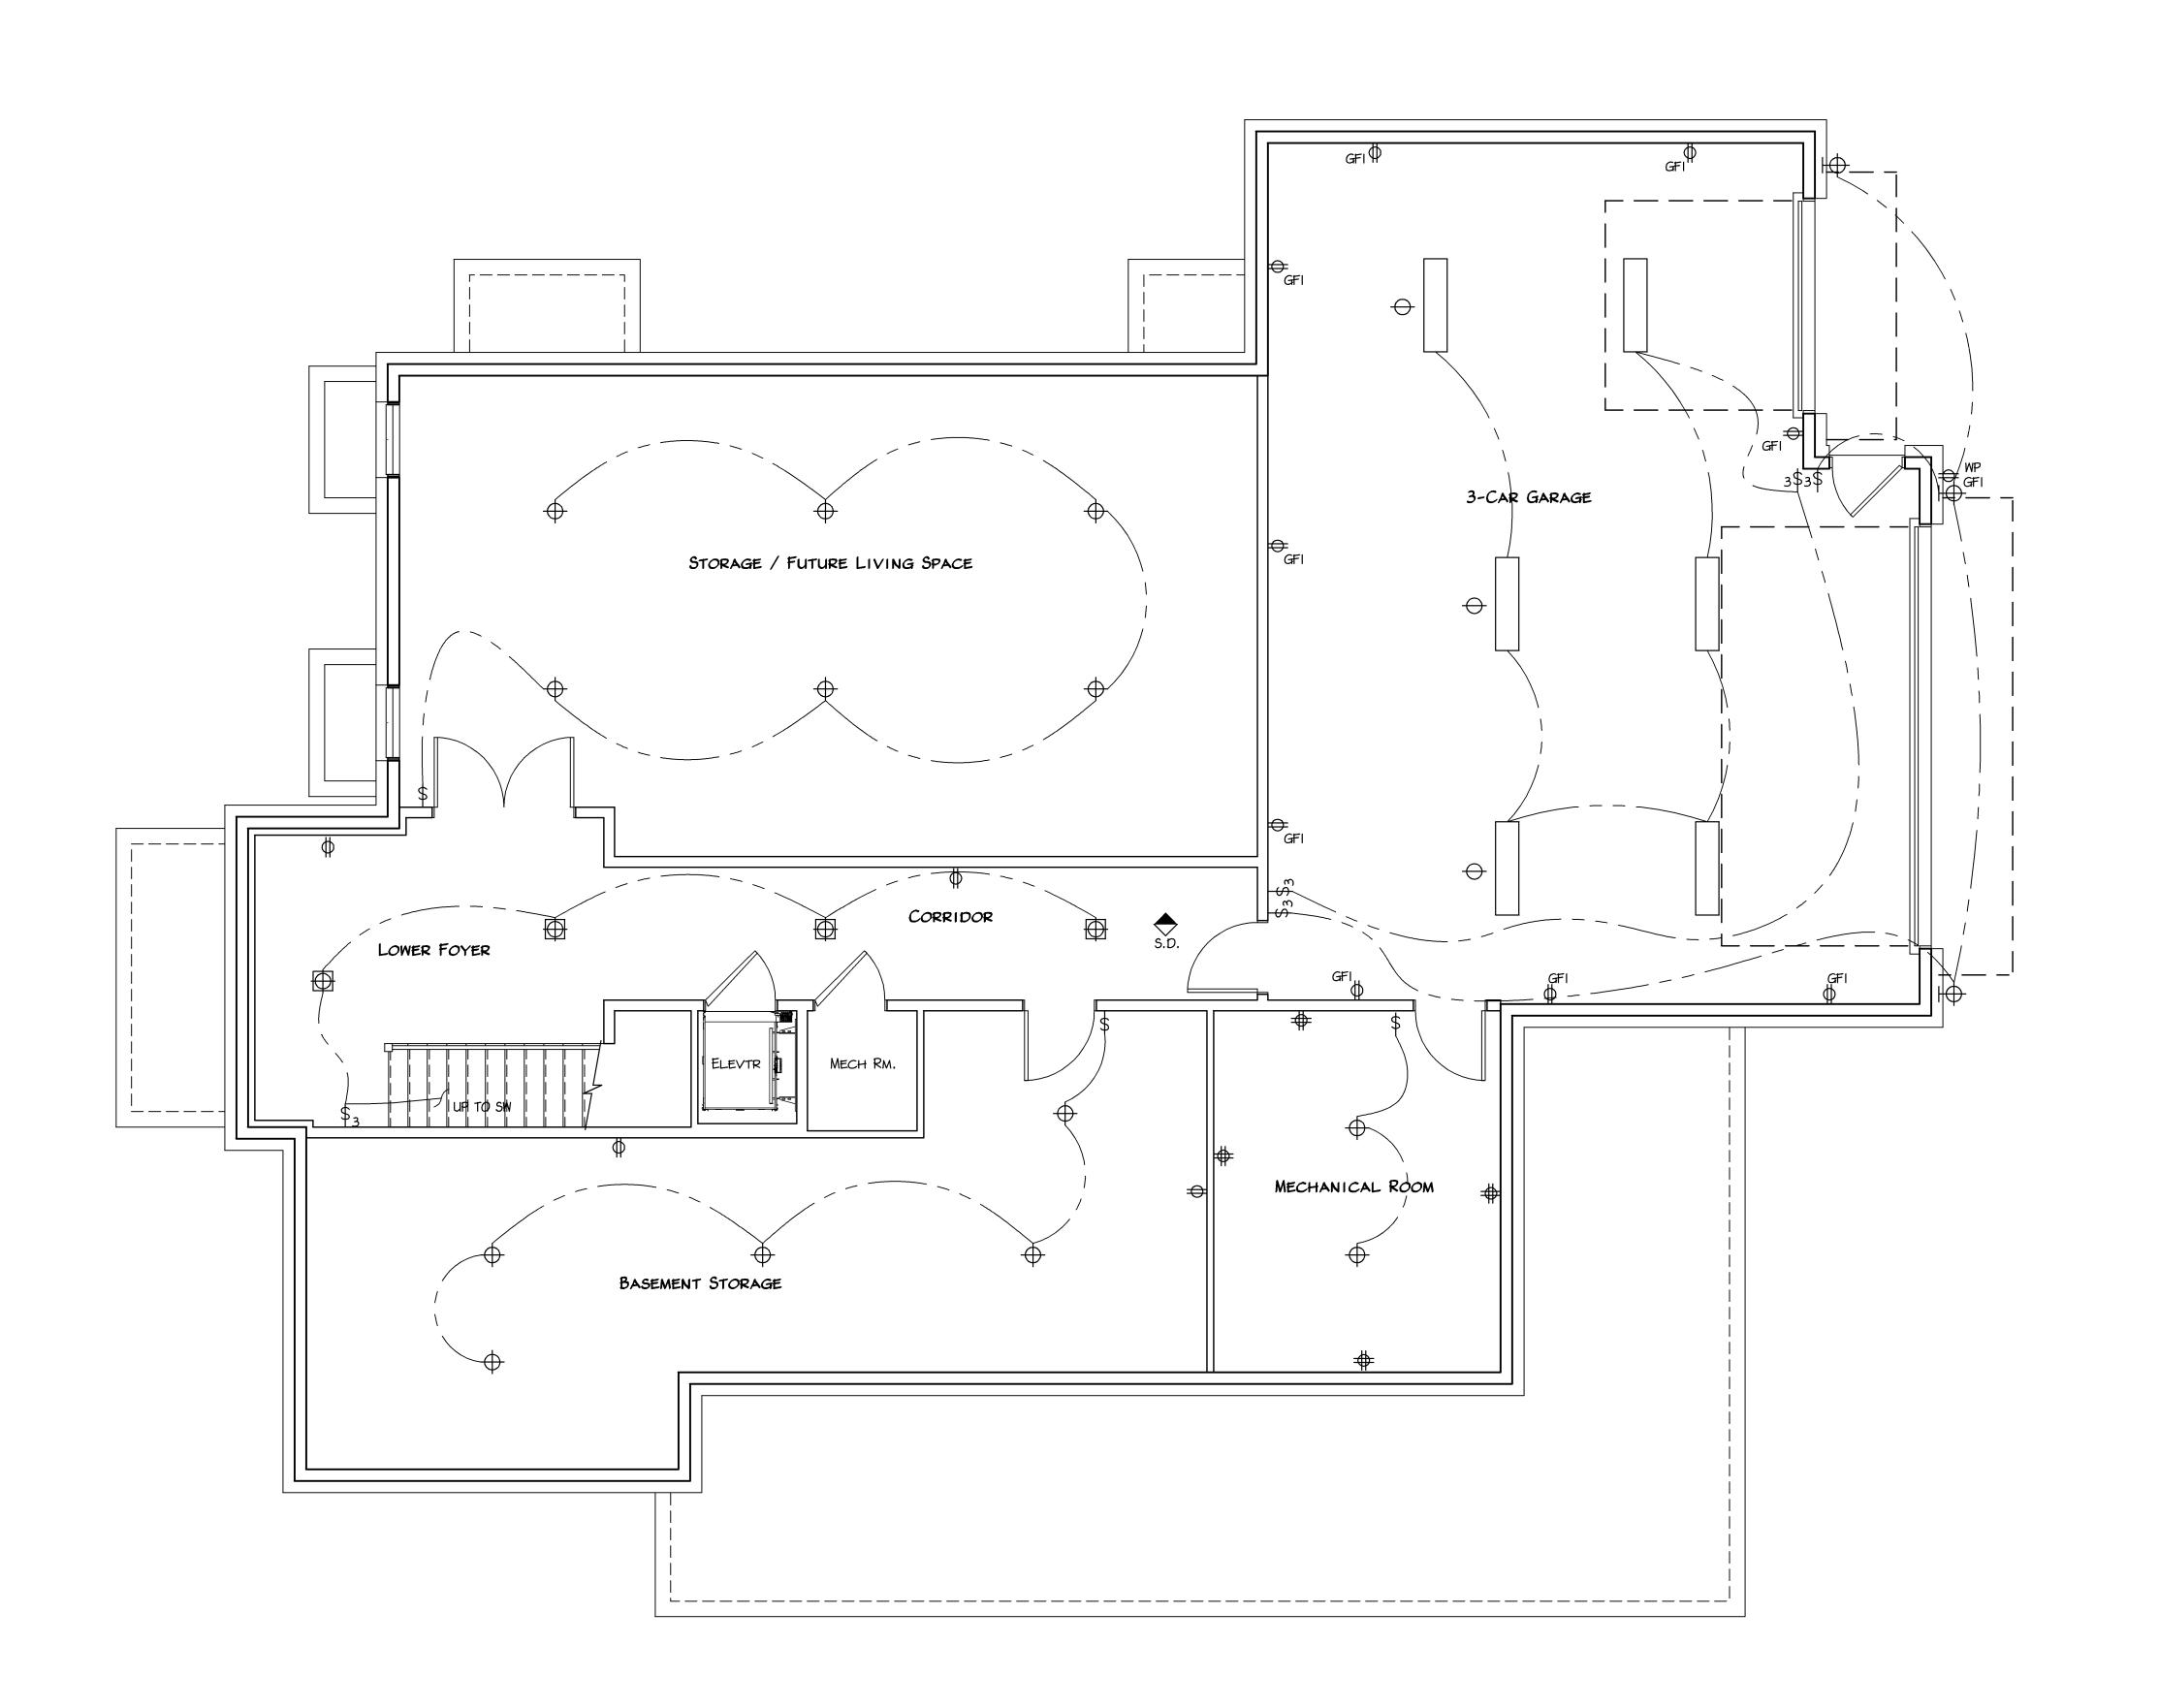

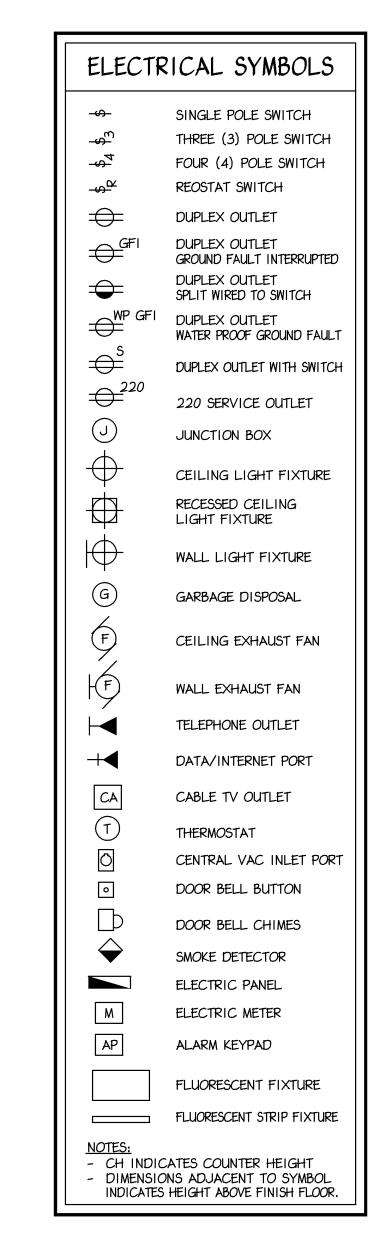

ALL SMOKE DETECTORS SHALL BE INTERCONNECTED.
ALL DETECTORS SHALL HAVE A PRIMARY 120 VOLT
SUPPLY AND A SECONDARY SYSTEM CONSISTING OF
A BATTERY BACK-UP.

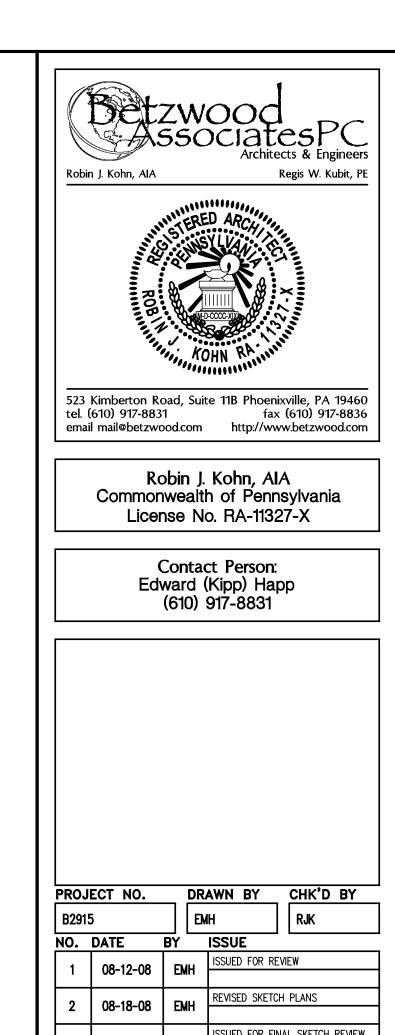

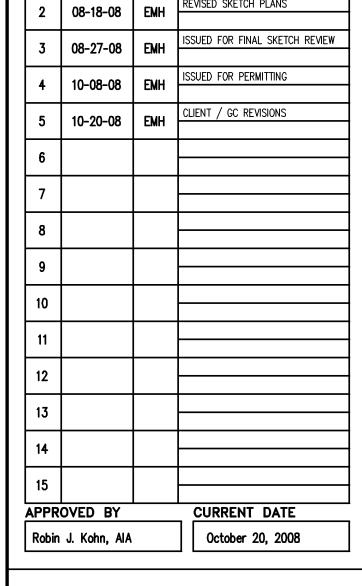

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PENN TOWNSHIP BERKS COUNTY

SHEET TITLE


ELECTRICAL BASEMENT PLAN


SHEET NUMBER

E-1


REV

1 BASEMENT ELECTRICAL PLAN
E-1 Scale: 1/4" = 1'- 0"

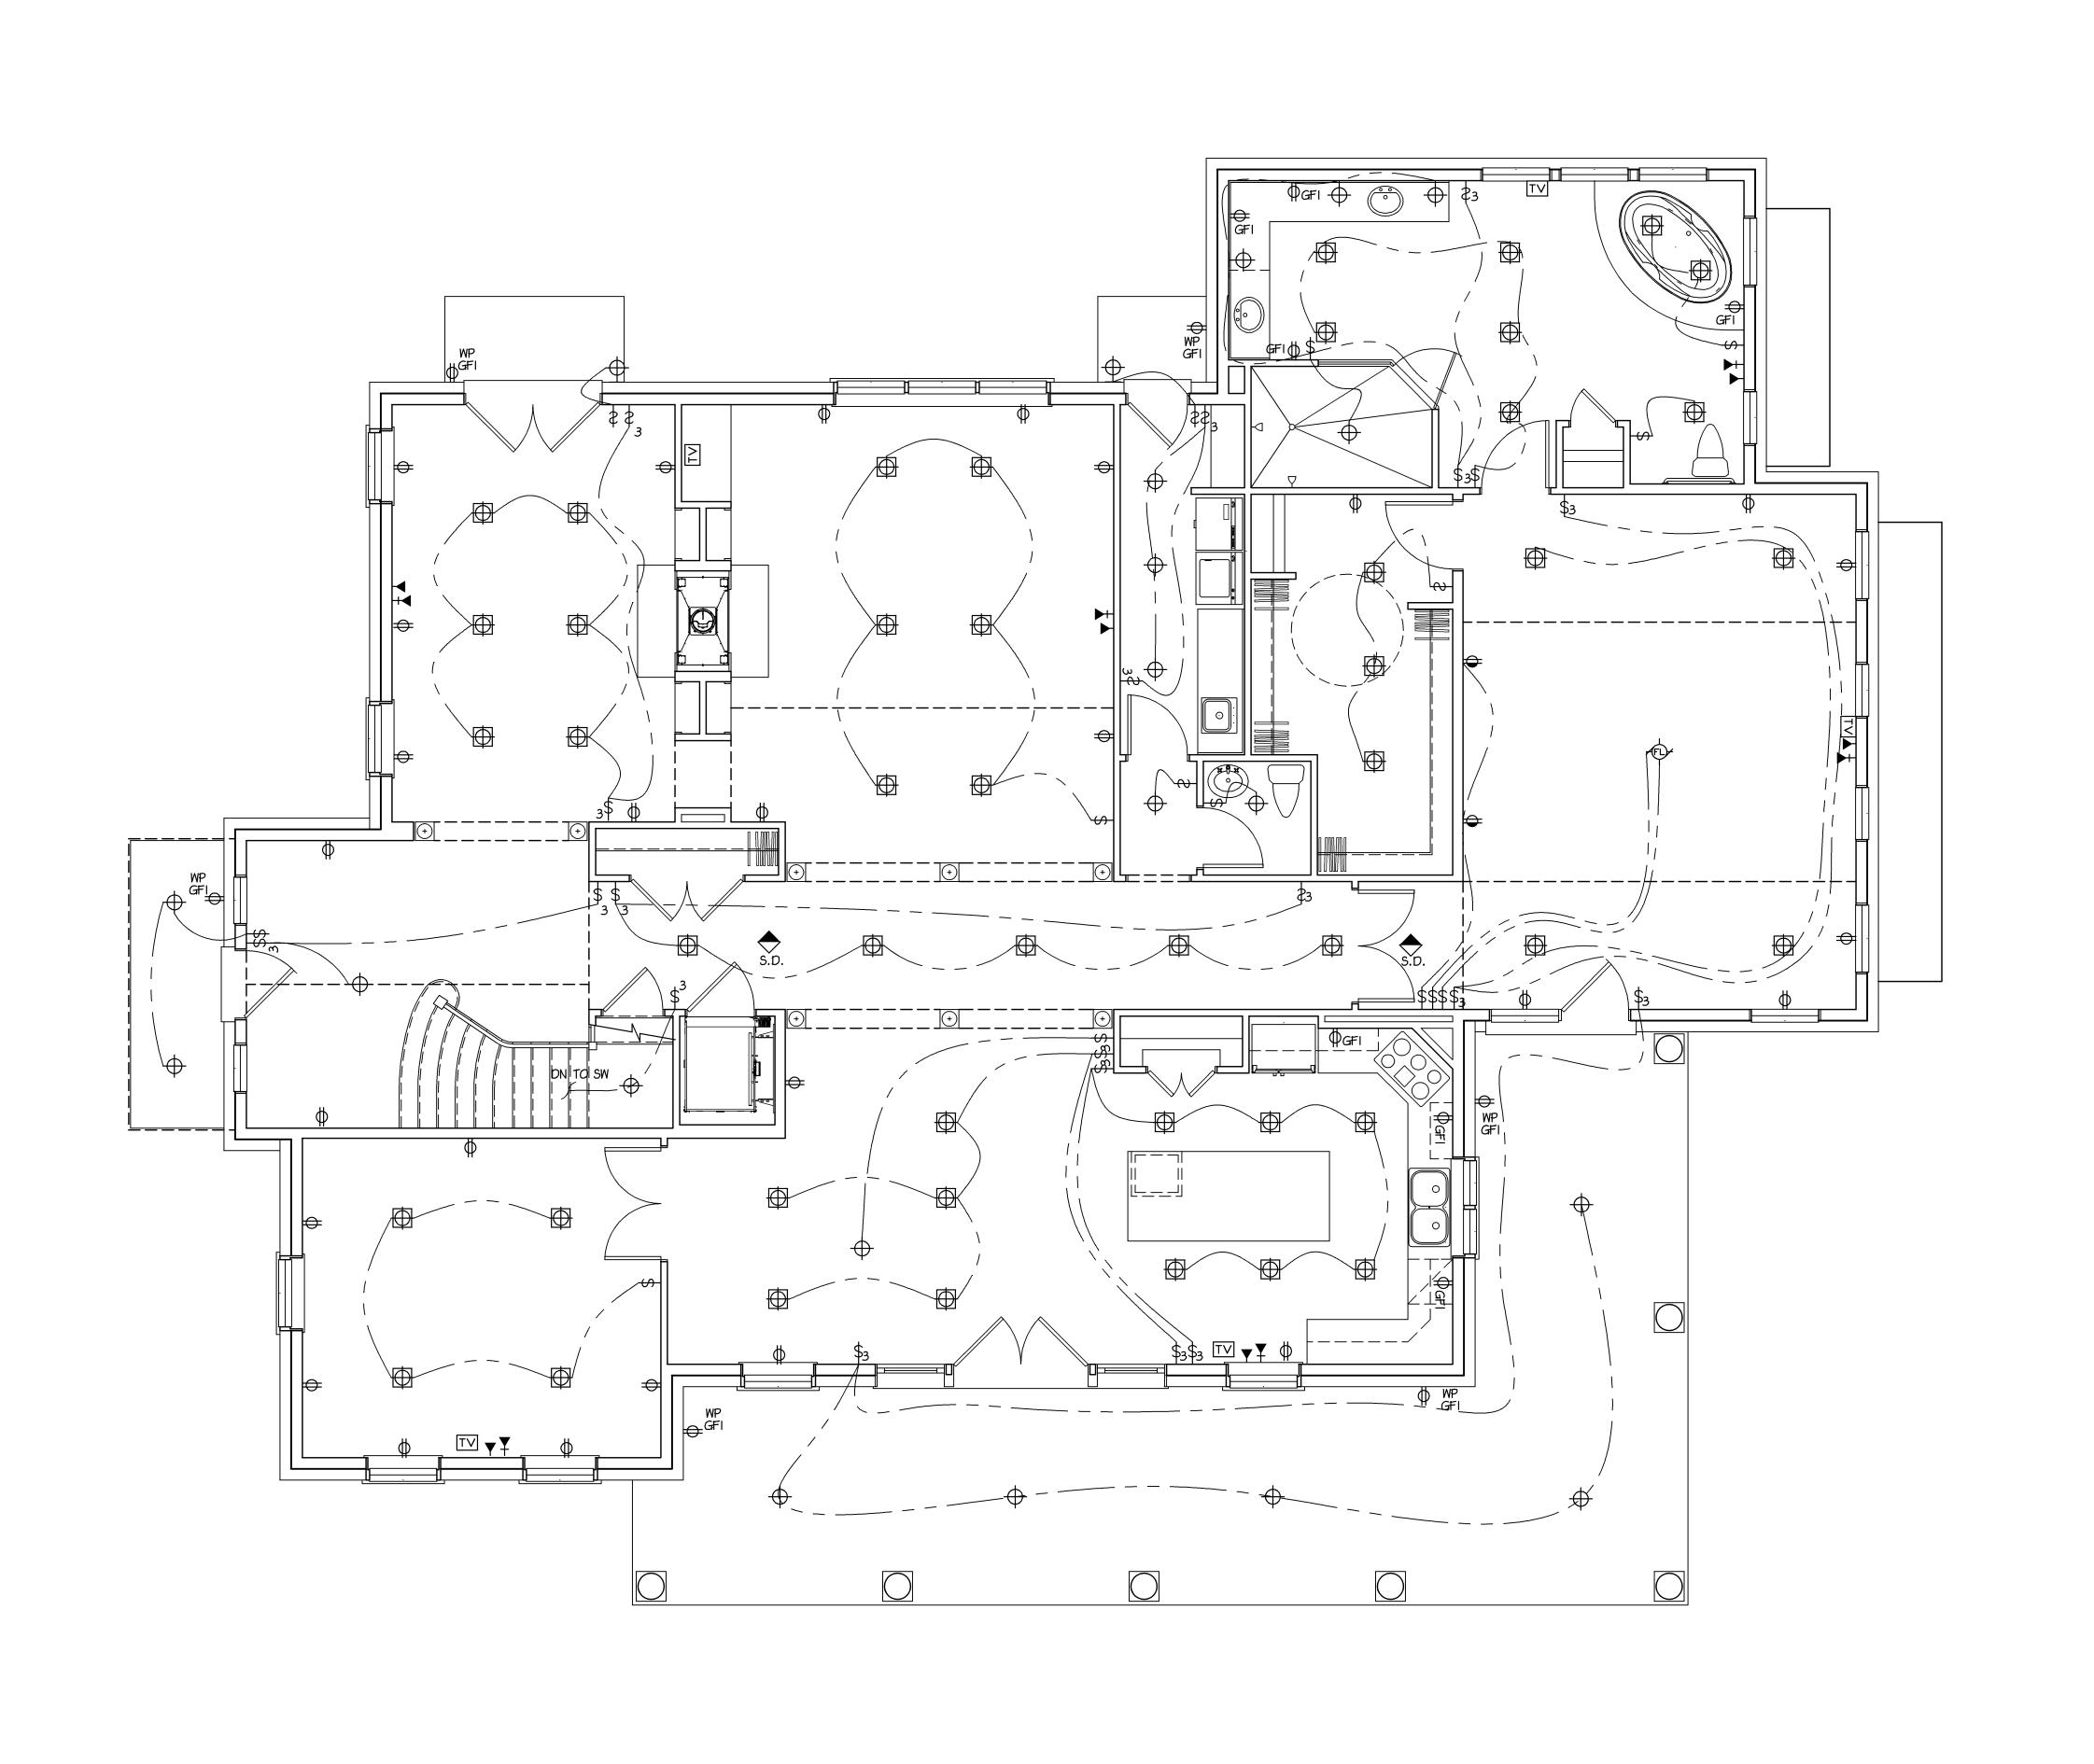

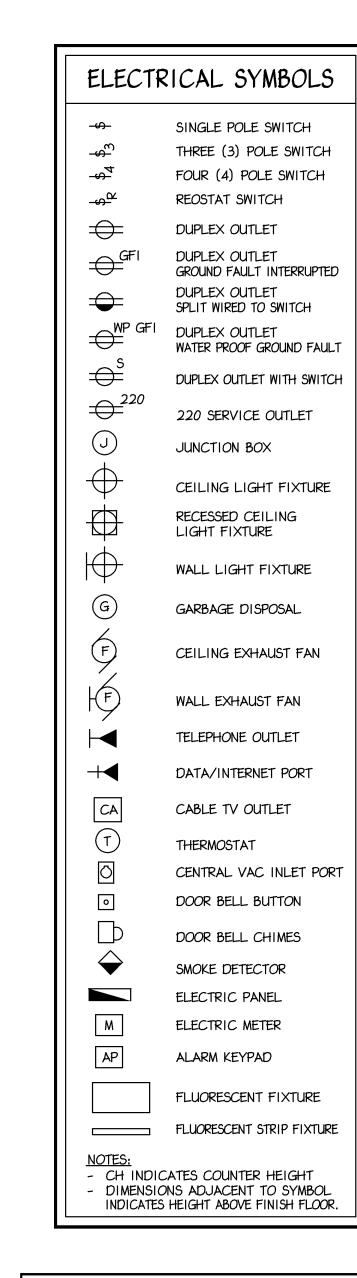

ALL SMOKE DETECTORS SHALL BE INTERCONNECTED.
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Shumaker Residence 183 DAVIS BRIDGE ROAD BERNVILLE, PA 19506

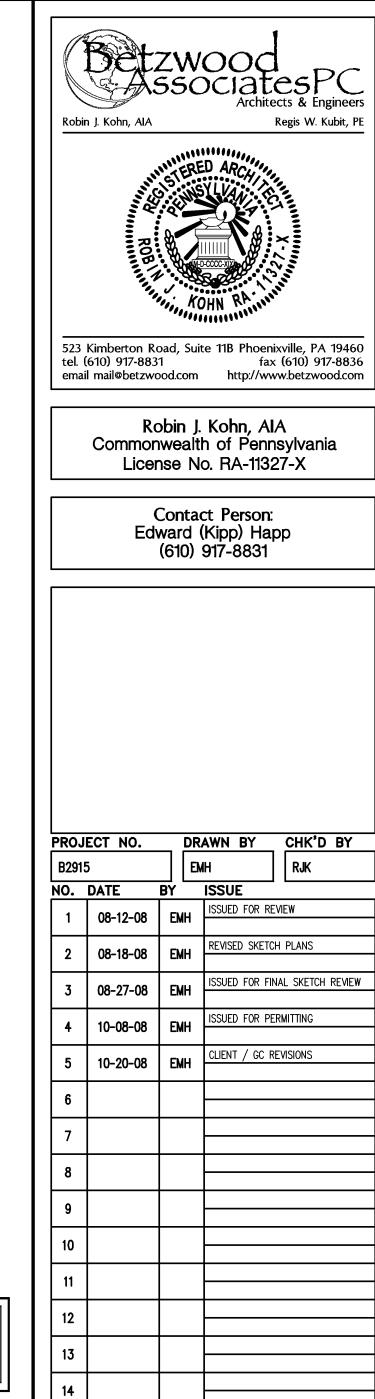CURRENT DATE

October 20, 2008

PENN TOWNSHIP BERKS COUNTY

SHEET TITLE

FIRST ELECTRICAL PLAN

SHEET NUMBER


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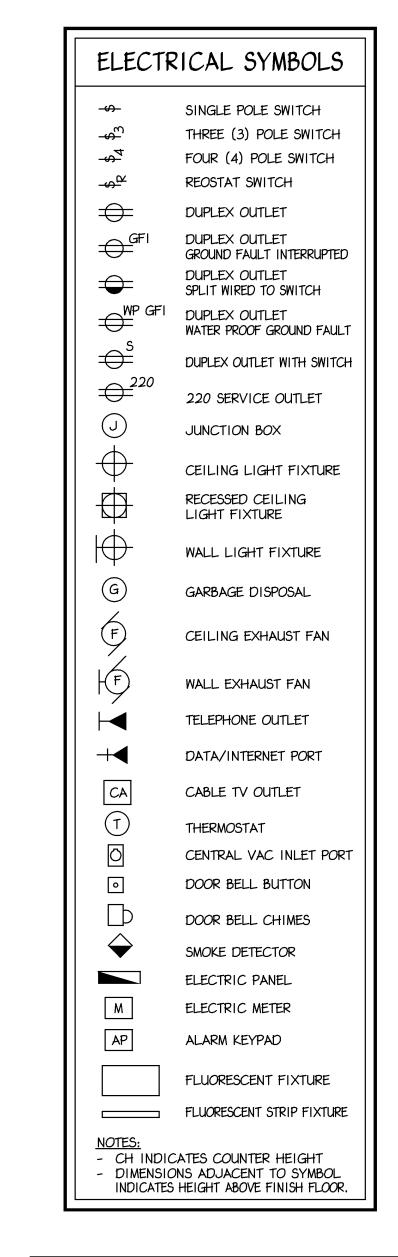
Robin J. Kohn, AIA

F-2


REV 5


1 FIRST FLOOR ELECTRICAL PLAN
E-2 Scale: 1/4" = 1'- 0"



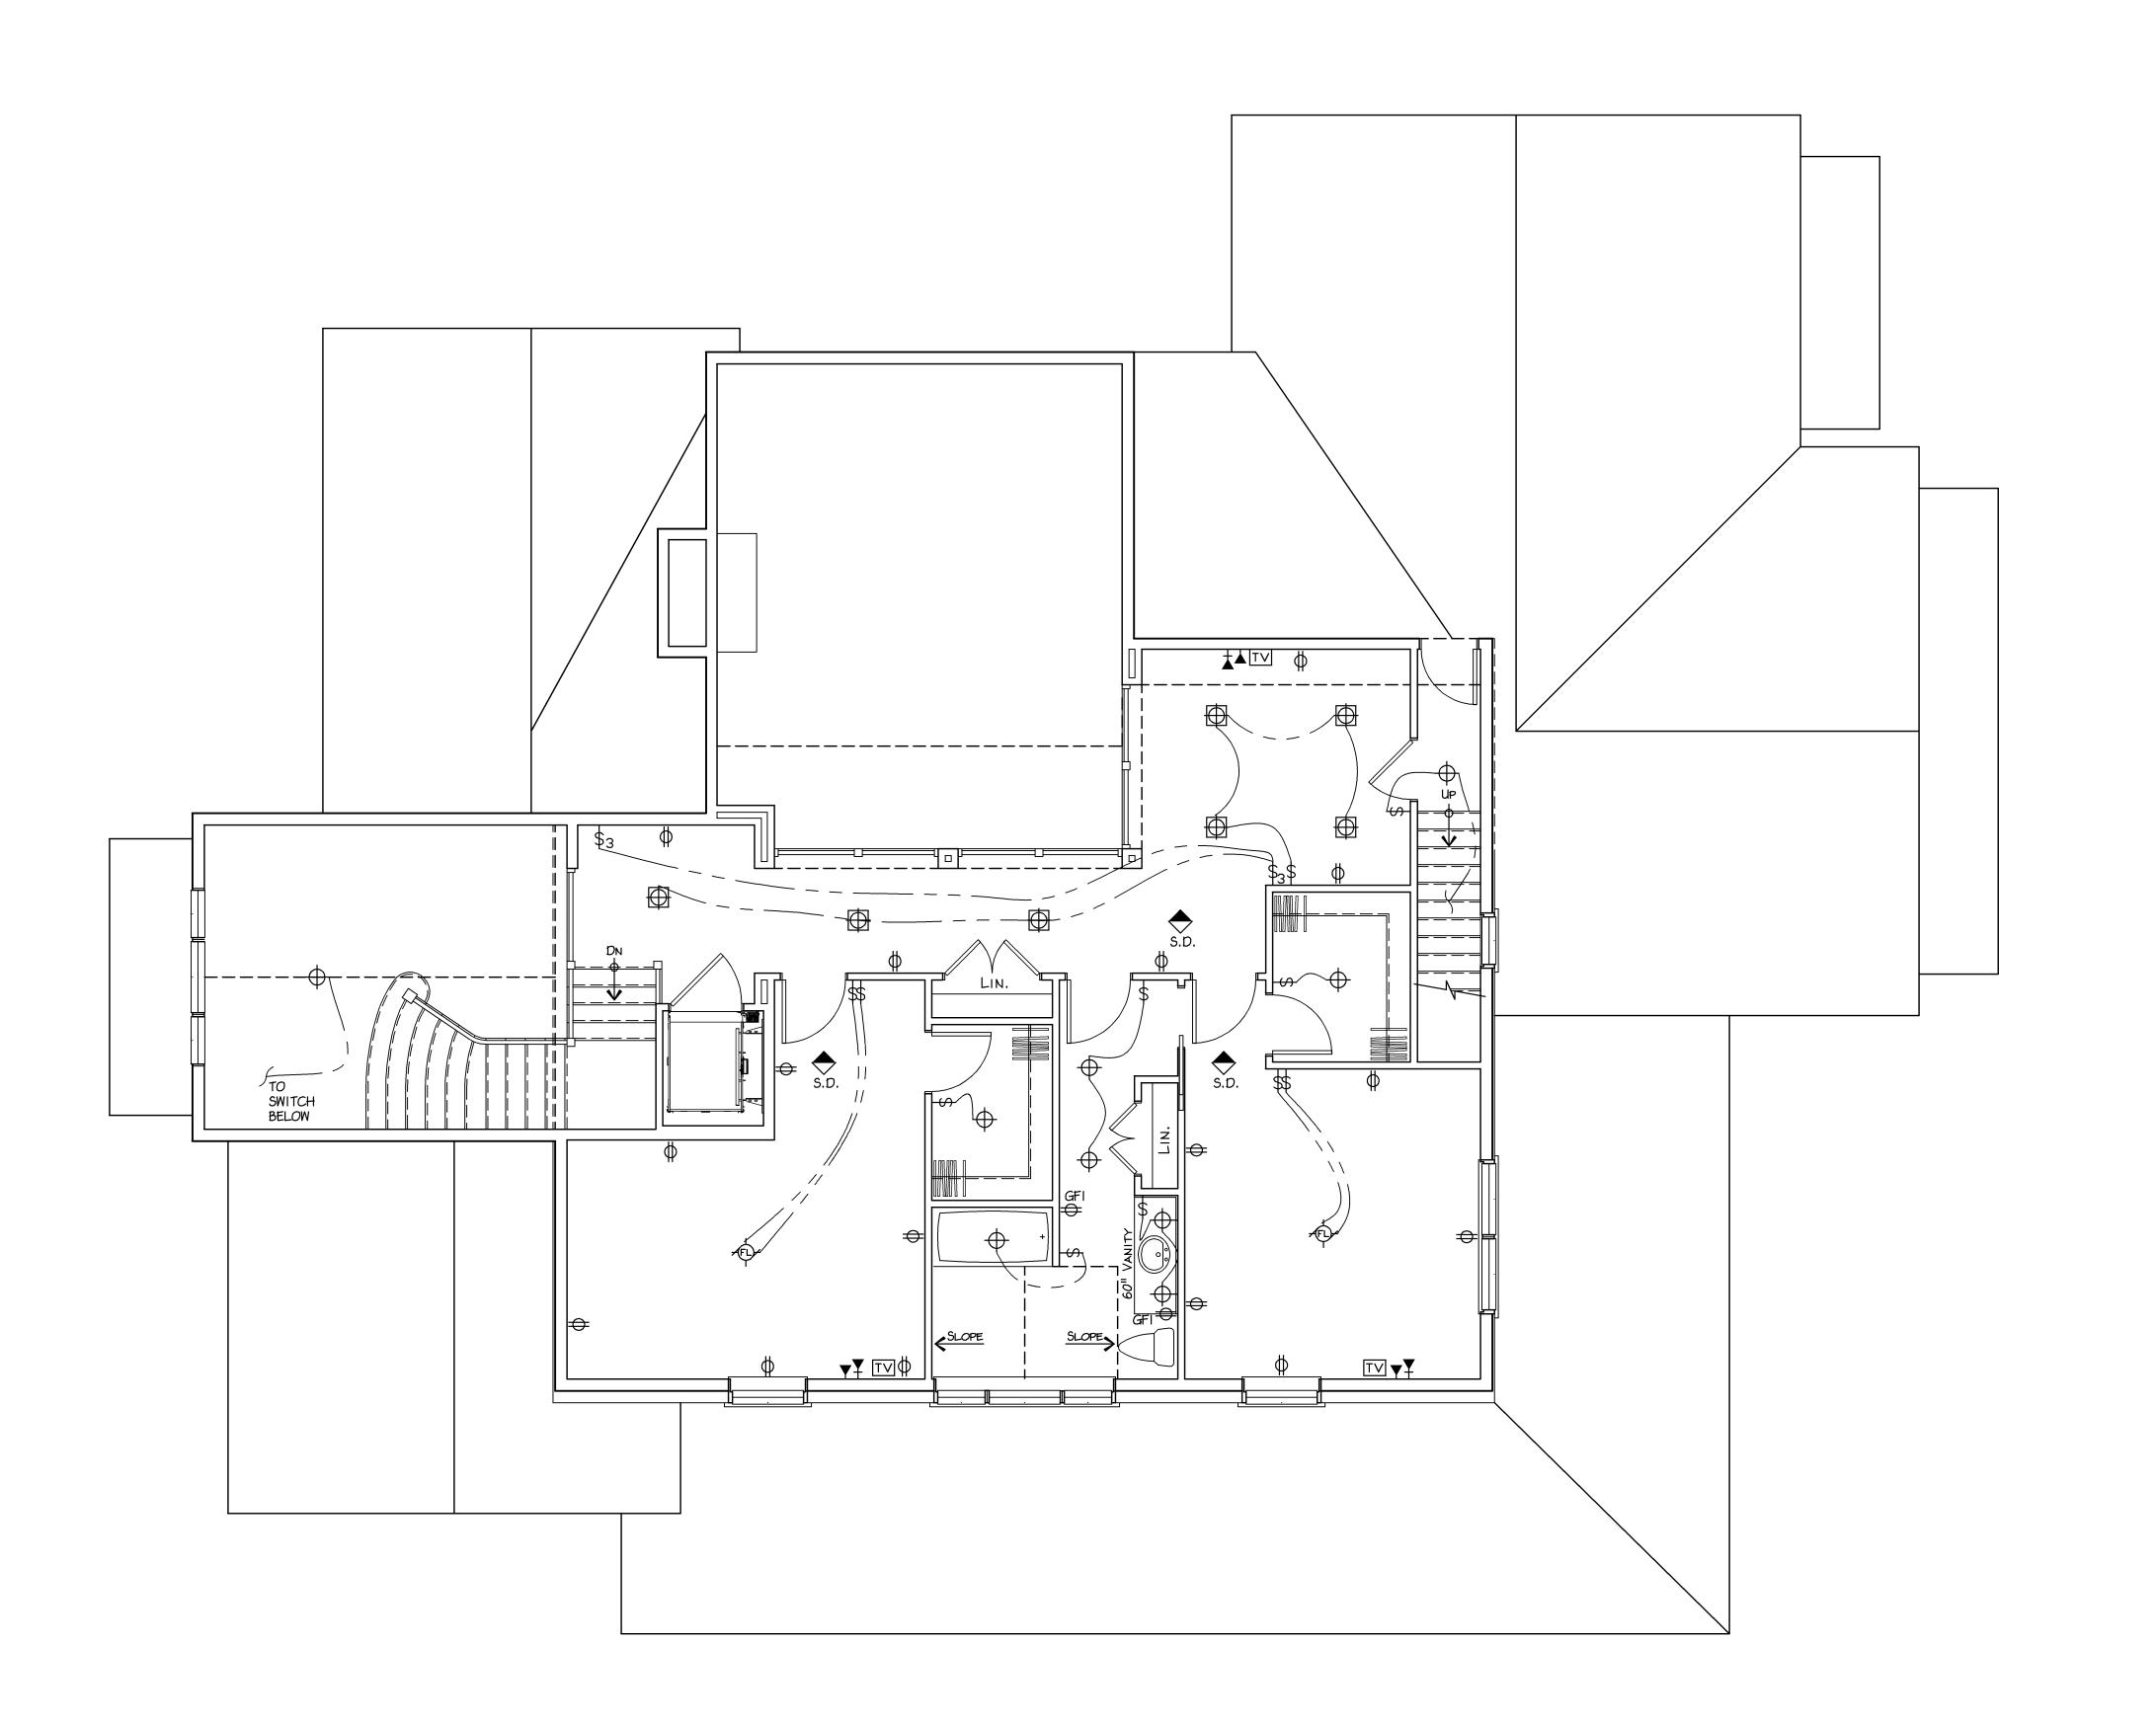

ALL SMOKE DETECTORS SHALL BE INTERCONNECTED.
ALL DETECTORS SHALL HAVE A PRIMARY 120 VOLT
SUPPLY AND A SECONDARY SYSTEM CONSISTING OF
A BATTERY BACK-UP.

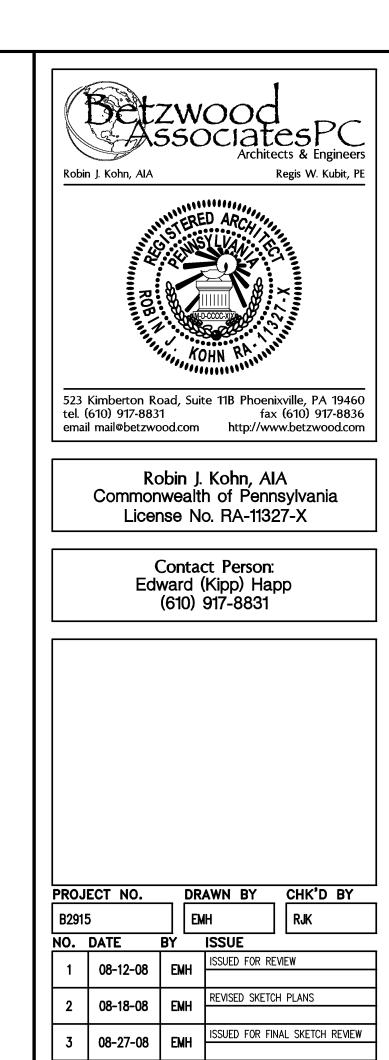

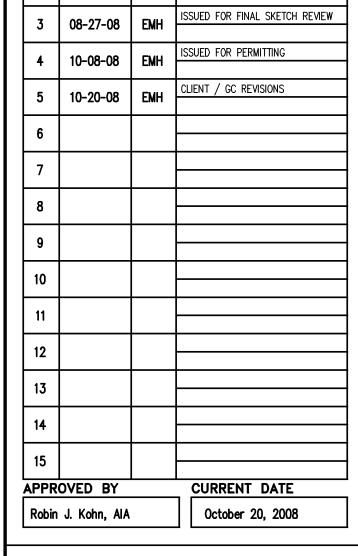

Shumaker Residence 183 DAVIS BRIDGE ROAD BERNVILLE, PA 19506

PENN TOWNSHIP BERKS COUNTY

SHEET TITLE

SECOND FLOOR ELECTRICAL PLAN

SHEET NUMBER

**E-3** 

REV 5

1 SECOND FLOOR ELECTRICAL PLAN

Scale: 1/4" = 1'- 0"